I-294/I-57 INTERCHANGE COOK COUNTY, ILLINOIS



ENVIRONMENTAL ASSESSMENT ADDENDUM - AMENDMENT

I-57/I-294 Interchange - Updates Based on Value Engineering Studies

FEBRUARY 2010





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Background and History

The Environmental Assessment (EA) for the I-294 at I-57 Interchange Project was approved by the Federal Highway Administration (FHWA) on August 20, 2008. The Environmental Assessment Addendum and Finding of No Significant Impact (FONSI) was approved by the FHWA on April 29, 2009.

The purpose of this document is to describe additional work and project updates along the I-294 at I-57 Interchange. The Environmental Assessment for the I-294 at I-57 project was approved for public comment on August 20, 2008 and the public comment period was held from August 25, 2008 to September 26, 2008. The Environmental Assessment Addendum, covering the addition of work along 147th Street and for updates to the I-294 at I-57 project was approved for public comment on January 14, 2009 and the public comment period was held from February 18, 2009 to March 20, 2009.

Subsequently, the Illinois Department of Transportation in conjunction with the Illinois Tollway, has continued to advance the engineering and environmental studies through a Value Engineering process for this project including the I-294 at I-57 system interchange and four surrounding service interchanges (I-57 at 147th St. Interchange, I-57 at 159th St. interchange, I-294 at 147th St. Interchange, and I-294 at US 6 interchange). The additional effort is classified as follows:

- Geometric revisions to the system ramps and CD Road along I-57 to revise the flyover type ramps to outside loop or 'turbine' configuration and the addition of Ramp F2 along southbound I-57 and revision to the toll plaza arrangements have been identified to reduce project construction cost and reduce right of way acquisition and property displacement. The addition of Ramp F2 allows greater flexibility in travel patterns in the system interchange.
- IDOT updated environmental studies in the Summer of 2009 for the revision of I-294 at I-57 Interchange Study, and the new work proposed for new Ramp F2. These studies included wetland delineation, threatened and endangered species, and botanical surveys. A Final Preliminary Site Investigation (PSI) for special waste issues was also received.

The intention of this Amendment is to document previously unreported impacts and updates associated with the additional improvements of Ramp F2 and toll plaza changes north of 147th Street on I-294 and note any changes to impacts previously reported in the I-294/I-57 EA and EA Addendum as a result of the subsequent engineering and environmental studies since the September 10, 2008 and February 18, 2009 Public Hearings.

New Project Improvements

The proposed changes include the addition of Ramp F2, allowing traffic from 147th Street to access southbound I-57 via a CD Road, eliminating one ramp connection to mainline I-57, the geometric revision of Ramps C and B to eliminate costly and visually intrusive

flyover ramps and replace them with conventional outside loop or 'turbine' configuration ramps. Additional revision includes the relocation of proposed toll plazas from north of 147th Street to north of I-57 on the ramps. Additional right-of-way acquisition will be required to accommodate Ramp F2 and a reduction in right of way acquisition and reduction in the number of impacted residential buildings (single family and multifamily) will be the result of toll plaza relocation. Refer to Appendix D, Exhibit D-5.

The following Table A-1, shows the differences between the three documents:

Table A-1 – Comparison of Impacts Environmental Assessment, Addendum and Amendment

Resource	Environmental	EA Addendum	EA Addendum
	Assessment (EA)		Amendment
Relocations/ROW	43 residences and	43 residences and	24 residences and
Impacts	2 businesses	3 businesses	3 businesses
•	require relocation.	require relocation.	require relocation.
	Approximately 32	Approximately 34	Approximately 29
	acres of land will	acres of land will	acres of land will
	be required for	be required for	be required for
	ROW.	ROW.	ROW.
Farmlands	No Impact.	No Change.	No Change.
Air Quality	No Impact.	No Change.	No Change.
Traffic Noise	Noise levels for	No Change.	Noise levels for
	245 residences		326 residences
	approach or exceed		approach or
	noise abatement		exceed noise
	criteria.		abatement criteria.
Natural Resources			
Vegetation	No Impact.	No Change.	No Change.
Wildlife	No Impact.	No Change.	No Change.
Threatened and	No Impact.	Two additional	No Change.
Endangered Species		State Threatened	
		Species in project	
		area.	
Trees	9,650 impacted	10,410 impacted	10,640 impacted
	trees	trees	trees
Natural Areas/Nature			
Preserves/Prairies			
Dropseed Prairie	3.1 acres	No Change.	No Change.
Gensburg-Markham	No Impact.	No Change.	No Change.
Markham-East	No Impact.	No Change.	No Change.
Markham-West	12.4 acres	No Change	11.32 acres
Sundrop Prairie	No Impact.	No Change.	No Change.
Paintbrush Prairie	No Impact.	No Change.	No Change.

Resource	Environmental Assessment (EA)	EA Addendum	EA Addendum Amendment
Water Resources and	Assessment (L11)		rimenament
Water Quality			
Midlothian Creek	No Impact.	No Change.	No Change.
Dixie Creek	190 ft. temporary	No Change.	800 ft. stream
	stream impacts	\mathcal{E}	relocation loop
	loop ramp,		ramp quadrant,
	130 feet temporary		130 ft. temporary
	stream impacts I-		stream impacts, I-
	294 culvert		294 culvert
	extension		extension
Belaire Creek	30 ft. temporary	No Change.	No Change.
	stream impacts		
	culvert extension		
Unnamed creek	No Impact.	No Change.	No Change.
Calumet Union Ditch	No Impact.	No Change.	No Change.
I-57 Ditch	1,700 ft. southern	No Change.	4,000 ft. south side
	ditch		of I-57 ditch
	4,000 ft. northern		1,700 ft. north side
D 1 G 1	ditch	N. Cl	of I-57 ditch
Park Creek	140 ft. temporary	No Change.	No Change.
	stream impacts for		
	culvert extension	N. Cl	NI CI
Groundwater	Temporary impacts	No Change.	No Change.
Resources	during construction		
Wetlands Jurisdictional	Ammovimotoly	Approximately 0	No Changa
Jurisdictional	Approximately 1.55 acres	11	No Change.
Non-Jurisdictional	Approximately	acres Approximately	No Change.
Non-Jurisdictional	2.26 acres	4.293 acres	No Change.
Floodplains/Floodways	Approx. 15.7 acres	No Change.	No Change.
r 100upiams/r 100uways	of 100-year	140 Change.	140 Change.
	floodplain impacts.		
	ino oup ium impuovov		
	An additional	No Change.	An additional
	approx. 7.4 acres		approx. 9.72 acres
	of 100-year		of 100-year
	floodplain impacts		floodplain impacts
	for loop ramp		for loop ramp
	detention.		detention
	Fill volumes in	No Change.	No Change.
	Phase II.		

Resource	Environmental	EA Addendum	EA Addendum
Historic and	Assessment (EA)	No Changa	Amendment No Change
	No Impact.	No Change.	No Change.
Archaeological Resources			
Special Lands			
Section 4(f) Resources Memorial Park	NT T	N. Cl	N. Cl
	No Impact.	No Change.	No Change.
Commissioner's Park	No Impact.	No Change.	No Change.
Posen Park	0.4 acres	No Change.	No Change.
Dropseed Prairie	No Impact.	No Change.	No Change.
G-M (Core)	No Impact.	No Change.	No Change.
G-M (south)	No Impact.	No Change.	No Change.
Ziebell Park	No Impact.	No Change.	No Change.
Sunset Park	No Impact.	No Change.	No Change.
L.E. Donnelly Park	No Impact.	No Change.	No Change.
Country Aire Park	No Impact.	No Change.	No Change.
McNeil Park	No Impact.	No Change.	No Change.
G. Pieterzak Memorial	No Impact.	No Change.	No Change.
Park			
Belaire Park	No Impact.	No Change.	No Change.
Gospel Center/Dresser	No Impact.	No Change.	No Change.
Park	-		
Radio Station Park	No Impact.	No Change.	No Change.
Roesner Park	No Impact.	No Change.	No Change.
Eddie Bard Park	No Impact.	No Change.	No Change.
Pedestrian Overpass	No Impact.	No Change.	No Change.
Section 6 (f) Resources	No Impact.	No Change.	No Change.
Special Waste	1		
Gasoline Spills	The project has a medium potential to impact three	No Change.	No Change.
	gasoline spill sites with the proposed ROW.		
USTs	The project has a medium potential to impact nine sites with the study area.	No Change.	No Change.
LUSTs	The project has a medium potential to impact three sites with the study area.	No Change.	No Change.

Resource	Environmental EA Addendum		EA Addendum
	Assessment (EA)		Amendment
Brownfields	The project has a	No Change.	No Change.
	medium potential		
	to impact three		
	sites with the study		
	area.		
Miscellaneous	The project has a	No Change.	No Change.
	medium potential		
	to impact one		
	miscellaneous site		
	with the study area.		
Asbestos	Several buildings	No Change.	No Change.
	were built prior to		
	1970 and may		
	include asbestos		
Aesthetics	Views from	No Change.	No Change.
	residences and of		
	prairies from		
	interstates		
Construction Impacts	Delays	No Change.	No Change.
Estimated	\$505 Million	\$579 Million	\$564 Million
Construction Cost (not	(2007)	(2009)	(2009)
including ROW costs)			

Environmental Assessment Addendum - Amendment

The Environmental Assessment Addendum – Amendment includes updates to the I-294/I-57 Interchange. The results of the analysis follow the section numbering of the Environmental Assessment document and references to changes in paragraph and sentence refer to the combination of material of the both the original Environmental Assessment and the Environmental Assessment – Addendum documents.

Signature Page: Interstate 294/Interstate 57 Interchange, Cook County, Illinois ENVIRONMENTAL ASSESSMENT

The last paragraph, sentences four, and five should be removed and replaced as follows:

There are 24 residential relocations and 3 business relocations and approximately 29.58 acres of new right-of-way that will be required. The proposed improvements impact approximately 4.293 acres of wetlands and 25.4 acres of floodplains.

1.0 PURPOSE AND NEED

Page 1-4, Section 1.1 Introduction

The second paragraph, last sentence should be removed and replaced as follows:

Both the Illinois Department of Transportation and the Illinois Tollway have committed funding for the engineering, property acquisition, and environmental mitigation as well as for the phased construction of the I-57 at I-294 Interchange Project.

2.0 ALTERNATIVES

Page 2-7, Section 2.3.2.1.2 Half Diamond Interchange at I-294 and 147th Street/Ramp Toll Plaza

The first paragraph, the second and third sentences should be removed and replaced as follows:

Each ramp will have a single lane, with potentially all electronic toll plaza included on the ramp pavement.

Page 2-8, Section 2.3.2.1.3 Collector-Distributor roads along I-294 and I-57

The following paragraph should be added to this section:

The toll plazas for traffic to enter I-294 northbound will be located at the convergence of the I-57 northbound to I-294 northbound ramp (Ramp B) and the I-57 southbound to the I-294 northbound ramp (Ramp D). The toll plazas for traffic to exit I-294 southbound will be located at the divergence of the I-294 southbound CD Road M to the southbound I-57 (Ramp M) and the ramp to I-57

northbound/147th Street (Ramp L). Each ramp will be served by a two-lane toll plaza with one electronic tolling lane and one cash lane.

Page 2-9, Section 2.3.2.2 Cost for the Preferred Alternative

The paragraph should be added to the end of the section:

Subsequent to the Value Engineering review and geometric revisions, an additional Cost Estimate Review analysis yielded a potential projected overall cost of \$564 million for mid-year of construction (2012), not including right-of-way acquisition and relocation costs.

3.0 AFFECTED ENVIRONMENT/ENVIRONMENTAL CONSEQUENCES

The following additional technical documents, investigations, letters, meeting minutes, and memoranda are provided in Appendix B:

- Biological Clearance Concurrence from IDNR, August 12, 2009
- Biological Clearance from IDOT dated August 28, 2009
- Final Preliminary Site Investigation (PSI, by IDOT), October 14, 2009

Page 3-12, Section 3.1.2 Social and Economic Environmental Consequences/ Preferred Alternative/ROW Acquisition and Relocations

The second paragraph, third sentence, should be revised as follows:

The estimated ROW needed for the proposed improvements includes 29.58 acres.

The fourth paragraph, first and second sentences, should be revised as follows:

A total of 24 residential buildings and 3 businesses will be relocated as part of this project. The relocation of the 24 residential buildings displaces approximately 49 families.

The fifth paragraph, first and second sentences should be deleted.

Page 3-14, Section 3.2 Farmland

No changes.

Page 3-15, Section 3.3 Air Quality

No changes.

Page 3-21, Section 3.4 Traffic Noise

Delete the entire section 3.4 Traffic Noise and replace with the following:

3.4 Traffic Noise

The FHWA has adopted criteria for evaluating noise impacts associated with federally-funded highway projects and for determining whether such impacts can be mitigated. The FHWA Noise Abatement Criteria (NAC) sets values which, when approached or exceeded, require the consideration of abatement measures. An impact is noted when the predicted noise level approaches, meets, or exceeds the NAC for that land use (Refer to the NAC in Table 3-10). All noise levels determined in this study are one-hour L_{eq} or L_{eq} (h).

Table 3-10: Noise Abatement Criteria (NAC) Hourly A-Weighted Sound Level in Decibels (dBA)

Activity Category	$L_{eq}(h)^1 (dBA)$	Description of Activity Category	
A	57 (Exterior)	Lands on which serenity and quiet are of extraordinary significance and serve an important public need and where the preservation of those qualities is essential if the area is to continue to serve its intended purpose.	
В	67 (Exterior)	Picnic areas, recreation areas, playgrounds, active sports areas, parks, residences, motels, hotels, schools, churches, libraries, and hospitals.	
С	72 (Exterior)	Developed lands, properties, or activities not included in Categories A or B above.	
D		Undeveloped lands.	
E ²	52 (Interior)	Residences, motels, hotels, public meeting rooms, schools, churches, libraries, hospitals, and auditoriums.	

Source: IDOT BDE Manual (2002)

Note: The NAC are noise impact thresholds for considering abatement. (Abatement must be considered when predicted traffic noise levels for the design year approach [i.e., are within 1 decibel of] or exceed the noise abatement criteria, or when the predicted traffic noise levels are substantially higher [i.e., are more than 14 decibels greater] than the existing noise level.) The NAC are not attenuation design criteria or targets. The goal of noise abatement measures is to achieve a substantial reduction in future noise level. The reductions may or may not result in future noise levels at or below the NAC.

IDOT regulations further define an impact as an "approaching" level of 1 dBA below the NAC. In addition, IDOT policy defines a traffic noise impact occurs when the noise levels increase more than 14 dBA over existing noise levels. For this study, IDOT noise criteria were used to determine the level of impact.

^{1.} $L_{eq}(h)$ – The hourly value of L_{eq} . L_{eq} is the equivalent, steady-state sound level, which in a stated period of time contains the same acoustical energy as the time-varying sound level during the same period. For purposes of measuring or predicting noise levels, a receptor is assumed to be at ear heights, located 5 ft (1.5m) above ground surface.

^{2.} Use of interior noise levels shall be limited to situations where exterior noise levels are not applicable; i.e., where there are no exterior activities to be affected by traffic noise, or where exterior activities are far from or physically shielded from the roadway in a manner that prevents an impact on exterior activities.

3.4.1 Traffic Noise Affected Environment

Land uses within the study area include residential, commercial, churches, parks, and recreational facilities. Along I-294 the residential areas are located north of I-57. The residential areas along I-57 are located north of I-294, near the Kedzie crossing, and near the 159th Street interchange. Commercial development is located primarily along 147th Street. The existing traffic noise level is predicted to range between 56 dBA and 75 dBA along I-294 and between 54 dBA and 70 dBA along I-57. Two hundred seventy-nine residences, 1 church, and 6 recreation areas experience traffic noise impacts. No commercial properties experience traffic noise impacts.

3.4.2 Traffic Noise Environmental Consequences

A total of 283 receptors (representing 725 residences, 1 church, 45 commercial units, and 9 recreational areas) were evaluated for noise impacts. Table C-1 in Appendix C presents a summary of the receptors, NAC, and the noise analysis results for the Existing (2003), No-Action (2030), and the Preferred Alternative (2030) conditions. Traffic noise abatement measures were considered for the receptors that approached or exceeded the NAC or receptors that will experience an increase in traffic noise levels of greater than 14 dBA from the existing noise levels. The noise abatement measures were evaluated for being effective at reducing traffic noise levels (at least an 8 dBA decrease) and being reasonable. According to IDOT's Noise Policy, noise abatement measures are economically reasonable if they cost \$24,000 or less per benefited residence (traffic noise levels reduced by at least 5 dBA as a result of a noise barrier). All of the I-294 noise barriers are under the jurisdiction of the Illinois Tollway. The Illinois Tollway has the authority to make the final decisions on construction of these barriers.

No-Action Alternative

Included in the No-Action Alternative are five noise barriers that are being constructed along I-294 as part of the separate I-294 Widening Project (see Figure 3-5 for the locations of the No-Action barriers). Under No-Action conditions, a total of 56 receptors (representing 87 residences, 1 church, 6 recreational areas, and 1 commercial unit) will approach or exceed the NAC. The No-Action traffic noise level is predicted to range between 55 dBA and 73 dBA along I-294 and between 57 dBA and 73 dBA along I-57.

Preferred Alternative

Under the Preferred Alternative, the five No-Action Noise Barriers built under the I-294 Widening project will either be fully or partially removed to construct the I-294/I-57 Interchange. A total of 115 receptors (representing 326 residences, 7 recreation areas, 1 Church, and 1 commercial unit) will approach or exceed the NAC if the No-Action Noise Barriers along I-294 (which are partially or fully removed) are not replaced. As shown in Appendix C, Table C-1, the Preferred Alternative traffic noise level is predicted to range between 59 dBA and 74 dBA along I-294 and between 56 dBA and 72 dBA along I-57.

Seven noise barriers were analyzed along I-57 and six noise barriers were analyzed along I-294. Table 3-11 presents a summary of the noise barriers analyzed. All of the I-294 noise barriers being evaluated are replacing either all or part of a No-Action Noise Barrier. All the evaluated barriers were effective in reducing traffic noise except Barrier 294-1 (maximum noise level reduction of 5 dBA). However, Barrier 294-1 will be considered for reasonableness because they will be replacing existing No-Action Noise Barriers that are being constructed as a part of I-294 Widening Project.


Since the I-294 Noise Barriers are replacing either all or part of the No-Action Noise Barriers, the cost effectiveness is analyzed for both the entire noise barrier and the replacement section. In addition, the cost per benefited receptor was completed for both the receptors that benefit from the entire noise wall and for those receptors that benefit from the replacement section. The analyses were completed for the entire wall to show the full benefits of the extension and the analyses were completed for only the replacement section to present the costs that will be incurred for this project.

All the Noise Barriers along I-294 are reasonable based on the cost per benefited residence, except Barrier 294-2 and Barrier 294-2A, as shown in Table 3-11. Barrier 294-2 and Barrier 294-2A are not considered economically reasonable because they exceed the cost criteria of \$24,000 per benefited receptor. However, the Illinois Tollway has decided to construct Barrier 294-2 because it will replace a 200-foot section of one of the noise barriers constructed as part of the I-294 Widening Project. Barrier 294-2 is the replacement of a section of a No-Action Noise Barrier which protects the actively used baseball diamond in Memorial Park. Since this barrier is not considered reasonable and is not eligible for federal-aid funds, the Illinois Tollway will construct this barrier with Illinois Tollway funds. Barrier 294-2A replaces the same section of the No-Action barrier as Barrier 294-2, but includes an additional 650-foot extension of the noise wall. It is not recommended since the additional length of Barrier 294-2A does not benefit any more receptors than Barrier 294-2.

The **seven** I-57 noise barriers are determined to not be cost-effective and are not recommended. The Preferred Alternative does not include any noise barriers along I-57. A final decision on the installation of the abatement measures will be made upon completion of the project design and the public involvement process.

Page 3-23, Section 3.4 Traffic Noise Figure 3-5

Remove and replace Figure 3-5 with the separate drawing:

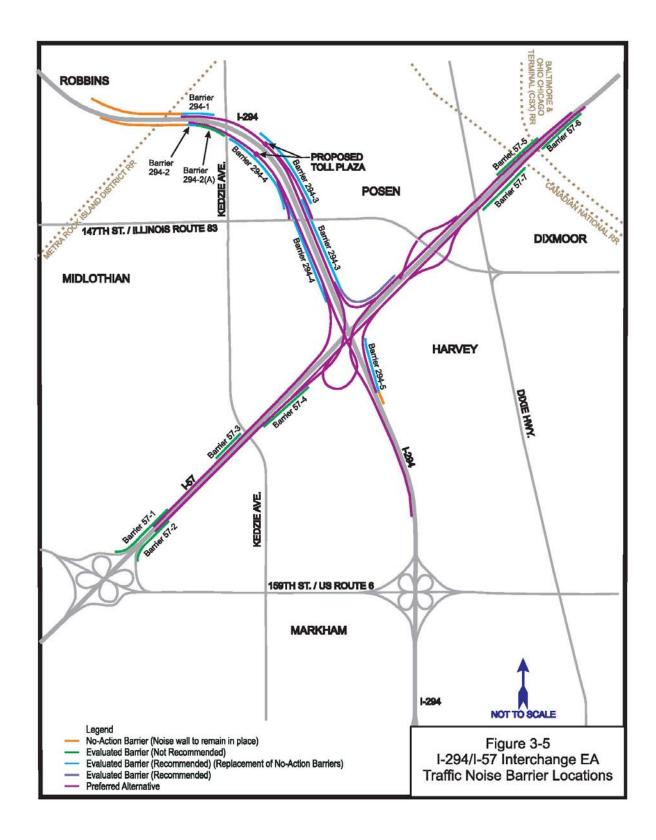

Page 3-25 Section 3.4 Traffic Noise. Table 3-11 Noise Barrier Cost Analysis Summary.

Remove and replace Table 3-11 with the following:

Table 3-11: Noise Barrier Cost Analysis Summary								
Barrier	Barrier Height (feet)	Barrier Length (feet)	Barrier Square Footage	Effective in Noise Reduction (achieves 8 dBA reduction)	Cost ¹	Number of Benefited Receptor	Cost per Benefited Receptor	Economically Reasonable
Barrier 57-1	14	2,260	31,640	Yes	\$791,000	15	\$52,700	No
Barrier 57-2	14-16	1,990	30,545	Yes	\$763,700	12	\$63,600	No
Barrier 57-3	19	810	15,390	Yes	\$384,800	2	\$192,400	No
Barrier 57-4	26	2,000	52,000	Yes	\$1,300,000	14	\$92,800	No
Barrier 57-5	13-16	2,425	33,300	Yes	\$832,500	8	\$104,000	No
Barrier 57-6	18-20	1,135	22,260	Yes	\$556,500	6	\$92,800	No
Barrier 57-7	13-15	1,385	20,125	Yes	\$503,100	8	\$62,900	No
Barrier 294-1	16 ²	1,050 ²	48,800/ 16,800 ³	No	\$1,263,900/ \$435,100 ³	134/4 ³	\$9,400/ \$108,800 ³	Yes
Barrier 294-2	20^{2}	200 ²	38,000/ 4,000 ³	Yes	\$984,200/ \$103,600 ³	35/1 ³	\$28,100/ \$103,600 ³	No
Barrier 294-2A	14 ²	850 ²	50,000/ 11,900 ³	Yes	\$1,295,000/ \$308,200 ³	35/1 ³	\$37,000/ \$308,200 ³	No
Barrier 294-3	13	6,850	89,050	Yes	\$2,226,200	159	\$14,000	Yes
Barrier 294-4	13-15	5,700	79,600	Yes	\$2,061,700	121	\$17,100	Yes
Barrier 294-5	14-16 ²	1,000 ²	21,650/ 14,500 ³	Yes	\$619,200/ \$414,700 ³	91/91 ³	\$6,800/ \$4,600 ³	Yes

^{1.} The costs of the I- 57 barriers were estimated based on \$25/square foot in accordance with IDOT's Noise Policy. The costs of the I-294 barriers are based on the actual costs of the No-Action Barriers from the I-294 Widening Project (\$25.90 to \$28.60/square foot). Using either IDOT's or the Illinois Tollway's cost per square foot of wall does not alter the economic reasonableness of the noise barriers.

Page 3-26, Section 3.5.2 Vegetation and Wildlife Environmental Consequences/Preferred Alternative

The first and second sentences of the first paragraph should be removed and replaced with the following:

^{2.} Values are for the replacement section only.

^{3.} Entire barrier (including the No-Action Barrier that remains in place and the replacement section)/replacement section only. The total benefited residences include the No-Action benefited residences.

Approximately 29.58 acres of additional ROW from over 150 separate parcels are required to construct the proposed project. Parcel acquisitions range in size from 0.02 acres to 9.72 acres. Refer to Appendix D, Exhibit D-5.

The fourth sentence should be removed and replaced with the following:

The largest parcel (9.72 acres), which occurs within the southern quadrant of the I-294/I-57 crossing, removes woodland and old field habitats.

The fifth sentence should be removed and replaced with the following:

There will be a loss of approximately 29.58 acres of urban wildlife habitat.

Page 3-30, Section 3.5.4 Threatened and Endangered Species Environmental Consequences/Preferred Alternative

The following paragraphs should be inserted at the end of the section:

An additional EcoCAT response from IDNR received August 12, 2009 identified the same Illinois Natural Area Inventory (INAI) sites and Nature Preserves as the EA in the project corridor.

Page 3-31, Section 3.5.6 Trees Environmental Consequences, Preferred Alternative The following paragraphs should be inserted at the end of the section:

Subsequent to Value Engineering studies, additional areas were identified that will be disturbed during construction. Transect methods have determined that an additional 230 trees will be impacted in the revised area of the interchange. The total number of impacted trees is 10,640.

Page 3-37, Section 3.6.2 Water Resources Environmental Consequences/Preferred Alternative

Dixie Creek

The first sentence should be modified as follows:

The words "two fly-over ramps" should be removed and replaced with "two system connection ramps".

The following paragraph should be added to end of this section:

Approximately 800 feet of the Dixie Creek channel will be relocated to a new channel further south and east to avoid the proposed loop ramp and the system connection ramps. The relocated Dixie Creek channel will also pass under one of the system connection ramps via a bridge structure.

Bellaire Creek

The first sentence should be modified as follows:

The words "proposed fly-over ramp" should be removed and replaced with "proposed system connection ramp".

Page 3-43, Section 3.7 Wetlands

No changes.

Page 3-49, Section 3.8.2 Floodway and Floodplain Environmental Consequences/Preferred Alternate

The first sentence of the last paragraph should be removed and replaced with the following:

Approximately 25.4 acres of impact to the 100-year floodplain occur as a result of the Preferred Alternative.

Page 3-50, 3.9 Historic and Archaeological Resources

No changes.

Page 3-51, Section 3.10 Special Lands

No changes.

Page 3-54, 3.11.1 Special Waste Affected Environment

The following should be inserted at the end of this section:

A *Preliminary Site Investigation Report* was completed (PSI, October 14, 2009), by the Illinois Department of Transportation. The PSI provided a review and summary of estimated quantities and costs of special waste and non-special waste disposal items, along with recommendations for Special Provisions.

Page 3-57, Section 3.12 Aesthetics

No changes.

Page 3-57, Section 3.13 Construction Impacts

No changes.

Page 3-58, Section 3.14 Indirect (Secondary) Impacts,

No changes.

Page 3-60, Section 3.15 Cumulative Impacts

No changes.

Page 3-61, Section 3.16 Permits

No changes.

Page 3-61, Section 3.17 Summary of Impacts
The following areas of Table 3-16 should be revised (changes in *bold/italic*):

Resource	No-Action Alternative Impact	Preferred Alternate Impact
		24 Residences and 3 businesses require relocation
Social and Economic		Approximately 29.58 acres of land will be needed for ROW
Traffic Noise		Noise levels for 326 residences approach or exceed noise abatement criteria
Natural Resources		
Trees		Approximately 10,640 impacted trees
Natural Areas/Nature Preserves/Prairies		
Markham-West ¹		Approximately 11.32 acres
Water Resources and Water Quality		
Dixie Creek		800 ft. stream relocation loop ramp quadrant, 130 ft. temporary stream impacts, I-294 culvert extension
I-57 Ditch		4,000 ft. south side of I-57 ditch 1,700 ft. north side of I-57 ditch
		Approximately 15.7 acres of 100-year floodplain impacts
Floodplains/Floodways		An additional approximately 9.72 acres of 100-year floodplain/impacts for loop ramp detention basin.

Resource	No-Action Alternative Impact	Preferred Alternate Impact
Estimated Construction Cost (Not including Right- of-Way or Relocation Costs)		\$564 million (2009 dollars)

¹Markham-West lands are owned by The Nature Conservancy as private preservation lands. It is not designated as a Nature Preserve or an Illinois Natural Area Inventory (INAI) site. Portions fall under the Stein Conservation Easement. Refer to Chapter 3 of the Environmental Assessment for further information.

4.0 MITIGATION MEASURES

Page 4-1, Section 4.1 Right of Way Acquisition and Relocations No text changes.

Page 4-1, Section 4.2 Traffic Noise

No text changes.

Page 4-1, Section 4.3.1. Trees

Remove all paragraphs in the section and replace with the following:

Mitigation of the approximately 10,640 trees that are estimated to be removed will be conducted in accordance with <u>IDOT Departmental Policies</u> (D&E - 18) by IDOT and the <u>ISHTA Criteria for Removal and Replacement of Trees</u> by ISHTA. The actual number of replacement trees may be adjusted during the final design based on the actual number of trees impacted. The potential exists within the project area to work with local natural resource agencies and groups to identify areas where replacement trees can be planted.

Based on the IDOT policy, the number of replacement trees is dependent on if balled and burlapped trees (1:1 replacement ratio) are used or seedlings (3:1 replacement ratio). Therefore, mitigation under the IDOT policy would require 10,640 balled and burlapped tree plantings or 31,920 seedling plantings.

The ISTHA policy mitigates trees based on the size of the tree being replaced with 6 to 12 inch trees being replaced at 1:1, 13 to 29 inch trees at 2:1 and 30 inch and greater being replaced at 3:1. Therefore, mitigation under the ISTHA policy would require approximately 14,808 tree plantings.

Page 4-1, Section 4.3.2 Natural Areas / Nature Preserves / Prairies, Markham-West Prairie

The first sentence should be removed and replaced with the following:

The impact to Markham-West Prairie parcels that are designated for conservation purposes is approximately 9.72 acres.

Page 4-2, Section 4.4 Water Resources and Water Quality

No text changes.

Page 4-3, Section 4.5 Wetlands

No text changes.

Page 4-3, Section 4.6 Floodplains/Floodways

No text changes.

Page 4-3, Section 4.7 Special Lands

No text changes.

Page 4-4, Section 4.8 Special Waste

No text changes.

Page 4-4, Section 4.9 Aesthetics

No text changes.

Page 4-4, Section 4.10 Construction Impacts

No text changes.

Page 4-5, Section 4.11 Summary of Mitigation Measures, Table 4-1

Table 4-1 should be revised as follows (changes in *bold/italic*):

Resource	Impact	Mitigation
Relocations/ROW Impacts	24 residences and 3 businesses require relocation.Approximately 29.58 acres of land will be required for ROW.	Uniform Relocation Assistance and Real Property Acquisition Policies Act of 1970, as amended (1989)
Traffic Noise	The noise levels for approximately <i>326</i> residences will approach or exceed the noise abatement criteria.	Five noise barriers are proposed to mitigate the traffic noise. These barriers are replacing the No-Action barriers along I-294.
Natural Resources		
Trees	Approximately 10,640 impacted trees	10,640 replacement trees (balled and burlaped, IDOT policy)

Resource	Impact	Mitigation
Natural Areas/Nature Preserves/Prairies		
Markham-West ¹	Approximately 11.32 acres	2 acres of prairie restoration, enhancement, and/or preservation or land acquisition to be conducted within the Indian Boundary Prairies complex.
Water Resources and		
Water Quality		
Dixie Creek	800 ft. stream relocation loop ramp quadrant,130 ft. temporary stream impacts,I-294 culvert extension	Best Management Practices (BMPs) for construction to be determined during final design.
I-57 Ditch	4,000 ft. south side of I-57 ditch 1,700 ft. north side of I-57 ditch	Best Management Practices (BMPs) for construction to be determined during final design.
Floodplains/Floodways	Approximately 15.7 acres of 100-year floodplain impacts An additional approximately 9.72 acres of 100-year floodplain/impacts for loop ramp detention basin.	Coordination with local municipalities and IDNR regarding impacts to the FEMA floodway and floodplain and to obtain required permits.

¹Markham-West lands are owned by The Nature Conservancy as private preservation lands. It is not designated as a Nature Preserve or an Illinois Natural Area Inventory (INAI) site. Portions fall under the Stein Conservation Easement. Refer to Chapter 3 of the Environmental Assessment for further information.

5.0 COMMENTS AND COORDINATION

Page 5-1, 5.1 Public Involvement

The following should be added to the end of this section:

NOTE: Additional Public Involvement material to be added after Public Informational Meeting.

APPENDIX A: List of Acronyms and Abbreviations

No changes.

APPENDIX B: Correspondence

See additional material in separate section.

APPENDIX C: Noise Analysis Results Summary Table

Remove Table C-1 in its' entirety and replace with revised tables with location exhibits.

APPENDIX D: Exhibits.

Remove Exhibit D-1, *Proposed Plans – 147th Street* and replace with Exhibit D-5 Remove Exhibit D-2, *Potentially Impacted Properties*, replace with Exhibit D-5 Remove Exhibit D-3, *Proposed Right-of-Way Acquisition*, replace with Exhibit D-5

New Exhibit D-5 (Sheets 1-20), *Potentially Impacted Properties/Proposed ROW Acquisition*, updates design and preliminary right-of-way information. Exhibit D-5 combines material previously presented in Exhibits D-1, D-2, and D-3.

Appendix B Correspondence



Wetlands

ubmittal Date: 07/14/2008 Sequence No: 14550							
District: 1 Requesting Agency: DOH Project No:							
ontract #: Job No.: P- 91-186-08							
ounties: Cook							
oute: FAI 57 Marked: I-57							
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lieu miles							
unicipality(les). See add time							
romTo (At): @ I-294 uadrangle: Blue Island, Harvey Township-Range-Section: T36N, R13E, Sec. 12&13							
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nticipated besign Approval. 02/20/2009							
leared for Letting: 08/28/2009 Mitigation: Yes Mitigation Completed:							
nitial Strivey and WIE Addendum No:							
Results Wetland District WIE WIE Wetland Resp to Coord							
Initiated Due Date Received Present Notified Requested According to Original Present Notified Representation (Notified Representation Presentation Prese							
0/02/2008 11/30/2006 12/04/2008 Tes 01/30/2009 Tes 01/30/2009							
omments: Dst. wants wet del asap; 12/30/08: ISTHA responded to draft BRR; 1/23/09: hand delivered standard							
action letter to Malone; concur (SED)							
Clearances: Cultural: 8/28/2008 Bio 1/12/2009 SW 1/20/2009							
· · · · · · · · · · · · · · · · · · ·							
Submittal Date: 07/28/2009 Sequence No: 14550 A							
District: 1 Requesting Agency: DOH Project No:							
Contract #: Job No.: P- 91-186-08							
Counties: Cook							
Route: FAI 57 Marked: I-57							
Street: Section:							
Omitee							
municipality(les). See add that 110 110 110 110 110 110 110 110 110 11							
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Processing	ISTHA mitigating on-site within Indian Boundary Prairies per EA; 1/23/09: Malone concur (SED)
Comments:	

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Wellaguau (backs	HUGHUL

Submittal Date:	01/20/2009 Submitted By:				
Does the project have wetland impacts?	Yes Type: Permanent				
Briefly describe the measures considered to avoid and minimize adverse impacts to the wetlands:	Side slopes will be constructed as steep as allowable to minimize impacts. Appropriate erosion control measures will be implemented to minimize impacts to adjacent wetlands that are unaffected.				
Summarize briefly why there are no practicable alternatives to the use of the wetland(s):	ROW area is needed for expansion of intersection in this area. Adjusting roadway geometry to avoid would require property acquisition and displacement of residents, businesses, etc.				
Wetland mitigation is being proposed:	within the project limits (on-site)				

Memo Date:	08/28/2009	Memo By:	Susan Dees			
Memo:	Wetland delineations for Addendum A were conducted by Huff and Huff consultants. They acceptable to this office. No wetlands were found. Addendum A is thus cleared for construvith respect to wetlands. If there are questions, please contact me at 217/785-0150.					
Memo Date:	01/23/2009	Memo By:	Susan Dees			
Memo:	The Wetland Impact Ev	/aluation form wa	s received 1/20/09 by this office and is acceptable. The			

project shall be processed as a Standard Review Action in accordance with the IDOT Interagency Wetlands Action Plan. Mitigation is considered on-site since it shall be performed within one mile of the project area. Wetland Sites #12, #13, #14, and #15 shall be impacted totalling 4.353 acres. All of the impacted wetlands are isolated. Because impacts to Wetlands #12 and #13 are less than 0.5 ac per wetland, they shall likely be mitigated at a ratio of 1.5:1.0 with mitigation acreages 0.344 and 0.146 acres respectively. Because impacts to Wetlands #14 and #15 totally destroy each wetland, they shall likely be mitigated at a ratio of 2.5:1.0, with mitigation acreages of 7.585 and 2.483 acres respectively. Total mitigation acreage may be up to 10.5565 acres. IDOT and ISTHA have separate agreements with IDNR which determine the mitigation ratios for each impact. The minimum mitigation ratio that will be applied to isolated wetland impacts will be 1.5:1.0. The highest ratio that will be responsible for coordinating all final ratios with IDNR once the design is finalized and prior to the permitting

wetland impacts will be 1.5:1.0. The highest ratio that will be applied to isolated wetland impacts, depending on wetland quality, will be 5.5:1.0. ISTHA will be responsible for coordinating all final ratios with IDNR once the design is finalized and prior to the permitting process. Because this project is a Standard Review Action, it shall be coordinated with Mr. Patrick Malone of IDNR Office or Resource Review and Coordination. Upon his concurrence, this project shall be considered cleared for letting with respect to wetlands. If there are questions, please contact me at 217/785-0150.

Memo Date: 01/20/2009 Memo By: V. Ruiz

Memo:

ISTHA will be responsible for wetland mitigation. Mitigation will occur within The Indian Boundary Prairie Mitigation Site.

Wetland impacts and Mitigation Required. Acres of Size Acres of **Essential** Natural Site Type T&E Nature Compensation Impact Ratio Preserve Area Habitat (acres) No. .344 .229 1.5 0.229 No No 12 Wet Shrub No No 8.2 FQI Basin 07120003 Quadrangle Blue Island Describe the work: Fill .097 1.5 .146 0.097 No No Wet Mead No 13 3.5 FQI Quadrangle Blue Island Basin 07120003 Describe the work: 7.585 3.034 2.5 No 3.034 No No Wet Mead No 14 8.5 Quadrangle Blue Island FQI Basin 07120003 Fill Describe the work: 2.5 2.483 .993 0.993 Νo No No Forested 8.8 FQI Basin 07120003 Quadrangle Blue Island Describe the work: 10.557 4.353 Total

WD TO

Attention: Central Office BD&E

Environment Section

Room 330

Environmental Survey Request Addendum

A Project information: V Bio V Cultural Wetlands V Special Waste
Submittal Date: 07/28/2009 Sequence No: 14550 A
District: 1 Requesting Agency: DOH Project No:
Contract #: Job No.: P- 91-186-08
Counties: Cook
Route: FAI 57 Marked: I-57 Street: Section:
Silver. 1 Orniles
Municipality(les): See add tillio
FromTo (At): @ I-294 Quadrangle: Harvey Township-Range-Section: T36N, R13E, Sec. 12&13
Anticipated Design Approval: 05/31/2009
El Reasonnor Submittall (Cosckalitia) and elvis
Acquisition of additional ROW or easement Addendum: acres Total Project: acres
In-Stream Work Stream Name:
Other: Wetland survey to be done by Huff and Huff for addendum A.
VIIICI.
Field Sign Off (Bio & Cultural Only)
Field Sign Off (Bio & Cultural Only)
Addendum Description: Additional ROW required for Value Engineering, revised geometry.
Tree Removal?: Don't Know Number?: ha/ acres
Wetland defineation performed by: Consultant End. Species Consultation performed by: BDE
Contact Person: John Baczek Local Contact Person:
Telephone #: (847) 705-4104 ext.
Env.Contact: Sam Mead E-Mail: Telephone # 8477054101 Title/Company:
Telephone #: 8477054101 Title/Company:
Update Entire Project
✓ Addendum Only
☐ Field Sign Off (Bio & Cultural Only) ☐ Received in CO
The state of the s
BIOLOGICAL RESOURCES
NO SURVEY OR FURTHER
COORDINATION REQUIRED
O A A A A
Mounas C. a. 2201
SIGNED
(SED) DATE



Illinois Department of Natural Resources

One Natural Resources Way Springfield, Illinois 62702-1271 http://dor.state.il.us

Pat Quinn, Governor Marc Miller, Director

August 12, 2009

Susan Dees Illinois Department of Transportation-BDE 2300 South Dirksen Parkway Room 330 Springfield, IL 62764

Re: FAI 57 @ I-294, P-91-186-08, seq. 14550A, Add. A

Project Number(s): 1001356 [14550A]

County: Cook

Dear Applicant:

This letter is in reference to the project you recently submitted for consultation. The natural resource review provided by EcoCAT identified protected resources that may be in the vicinity of the proposed action. The Department has evaluated this information and concluded that adverse effects are unlikely. Therefore, consultation under 17 III. Adm. Code Part 1075 is terminated.

This consultation is valid for two years unless new information becomes available that was not previously considered; the proposed action is modified; or additional species, essential habitat, or Natural Areas are identified in the vicinity. If the project has not been implemented within two years of the date of this letter, or any of the above listed conditions develop, a new consultation is necessary.

The natural resource review reflects the information existing in the Illinois Natural Heritage Database at the time of the project submittal, and should not be regarded as a final statement on the site being considered, nor should it be a substitute for detailed site surveys or field surveys required for environmental assessments. If additional protected resources are encountered during the project's implementation, you must comply with the applicable statutes and regulations. Also, note that termination does not imply IDNR's authorization or endorsement of the proposed action.

Please contact me if you have questions regarding this review.

Steve Hamer
Division of Ecosystems and Environment
217-785-5500





1001356

14550A

08/11/2009

IDNR Project #:

Alternate #:

Date:

Applicant:

Illinois Department of Transportation-BDE

Contact:

Susan Dees

Address:

2300 South Dirksen Parkway

Springfield, IL 62764

Project:

FAI 57 @ I-294, P-91-186-08, seq. 14550A, Add. A

Address:

n/a, n/a

Description: Orig. job for new interchange I-57 @ I-294, etc. cleared by IDNR after extensive coordination; Add. A for addit. unknown quantity of ROW for value engineering & revised geometry. Huff & Huff did wetland delineations and found none.

Natural Resource Review Results

Consultation for Endangered Species Protection and Natural Areas Preservation (Part 1075)

The Illinois Natural Heritage Database shows the following protected resources may be in the vicinity of the project location:

Dropseed Prairie INAI Site

Gensburg - Markham Prairie INAl Site

Markham Prairie - East INAI Site

Paintbrush Prairie INAI Site

Sundrop Prairie INAI Site

Dropseed Prairie Nature Preserve

Gensburg-Markham Prairie Addition Natural Heritage Landmark

Gensburg-Markham Prairie Nature Preserve

Paintbrush Prairie Nature Preserve

Paintbrush Prairie Nature Preserve

Sundrop Prairie Nature Preserve

Alkali Bulrush (Bolboschoenus maritimus)

Eastern Prairie Fringed Orchid (Platanthera leucophaea)

Eryngium Stem Borer (Papaipema eryngii)

Henslow'S Sparrow (Ammodramus henslowii)

An IDNR staff member will evaluate this information and contact you within 30 days to request additional information or to terminate consultation if adverse effects are unlikely.

Location

The applicant is responsible for the accuracy of the location submitted for the project.

County: Cook

Township, Range, Section:


36N, 13E, 11

36N, 13E, 12

36N, 13E, 13

36N, 13E, 14

IL Department of Natural Resources Contact Steve Hamer 217-785-5500 Division of Ecosystems & Environment

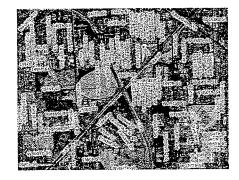

Local or State Government Jurisdiction IL Department of Transportation Susan Dees 2300 South Dirksen Parkway Room 330 Springfield, Illinois 62764

Disclaimer

The Illinois Natural Heritage Database cannot provide a conclusive statement on the presence, absence, or condition of natural resources in Illinois. This review reflects the information existing in the Database at the time of this inquiry, and should not be regarded as a final statement on the site being considered, nor should it be a substitute for detailed site surveys or field surveys required for environmental assessments. If additional protected resources are encountered during the project's implementation, compliance with applicable statutes and regulations is required.

Terms of Use

By using this website, you acknowledge that you have read and agree to these terms. These terms may be revised by IDNR as necessary. If you continue to use the EcoCAT application after we post changes to these terms, it will mean that you accept such changes. If at any time you do not accept the Terms of Use, you may not continue to use the website.

- 1. The IDNR EcoCAT website was developed so that units of local government, state agencies and the public could request information or begin natural resource consultations on-line for the Illinois Endangered Species Protection Act, Illinois Natural Areas Preservation Act, and Illinois Interagency Wetland Policy Act. EcoCAT uses databases, Geographic Information System mapping, and a set of programmed decision rules to determine if proposed actions are in the vicinity of protected natural resources. By indicating your agreement to the Terms of Use for this application, you warrant that you will not use this web site for any other purpose.
- 2. Unauthorized attempts to upload, download, or change information on this website are strictly prohibited and may be punishable under the Computer Fraud and Abuse Act of 1986 and/or the National Information Infrastructure Protection Act.
- 3. IDNR reserves the right to enhance, modify, alter, or suspend the website at any time without notice, or to terminate or restrict access.

IDNR Project Number: 1001356

Security

EcoCAT operates on a state of Illinois computer system. We may use software to monitor traffic and to identify unauthorized attempts to upload, download, or change information, to cause harm or otherwise to damage this site. Unauthorized attempts to upload, download, or change information on this server is strictly prohibited by law. Unauthorized use, tampering with or modification of this system, including supporting hardware or software, may subject the violator to criminal and civil penalties. In the event of unauthorized intrusion, all relevant information regarding possible violation of law may be provided to law enforcement officials.

Privacy

EcoCAT generates a public record subject to disclosure under the Freedom of Information Act. Otherwise, IDNR uses the information submitted to EcoCAT solely for internal tracking purposes.

To:

Diane O'Keefe

Attn: Pete Harmet

From:

Charles J. Ingersoll

By: Barbara H. Stevens

Subject:

Final Preliminary Site Investigation Report

Date:

October 14, 2009

Barbara H. Stevens

Refer to: FAI 57 (I-57)

Job No. P91-186-08

I-57 at I-294 Cook County

ISGS #1773 Sequence #14550

Weston5 Work Order #046

Attached is a copy of the completed Preliminary Site Investigation (PSI) Report submitted October 1, 2009 by Weston Solutions regarding the above referenced project. Based on the recommendations of the PSI report, if the District wants to pursue construction in the area of soil contamination, then the Contractor shall be responsible for hiring an Environmental Firm with at least five (5) documented leaking underground storage tanks (LUST) cleanups or that is pre-qualified in hazardous waste by the Department to remediate the soil contamination and monitor for worker protection.

An estimated quantity of potentially non-special waste has been included in the PSI report. The impacted soils would be classified as a non-special waste. The estimated cost associated with contaminated soil is \$32,900 at the Former Xtreme Auto Sales, \$63,900 at the John's Hot Dogs, \$73,100 at Walgreens, \$67,100 at the Citgo Gas Station, \$70,400 at the Valero Gas Station, \$177,700 at the Closed Gasoline Station, \$46,500 at the Dixmoor Fruit & Meat Market, \$85,200 at the Former Marathon Station, \$34,700 at the Harvey Express, and \$8,300 at the U Pull It. All utility companies relocating within the following areas should be notified of the potential soil contamination and the attached special provision shall be included in the contract plans.

- Station 1005+40 to Station 1006+60 0 to 100 feet RT (John's Hot Dogs, Site 1773-3, 3201 West 147th Street – Midlothian) – non-special waste. Contaminants of concern sampling parameters: BETX, SVOCs, and Arsenic.
- Station 1005+40 to Station 1006+60 0 to 100 feet LT (Former Xtreme Auto Sales, Site 1773-2, 3202 West 147th Street - Midlothian) – non-special waste. Contaminants of concern sampling parameters: BETX and SVOCs.
- Station 1006+60 to Station 1007+75 0 to 100 feet LT (CITGO, Site 1773-5, 3144 West 147th Street - Posen) – non-special waste. Contaminants of concern sampling parameters: BETX and Arsenic.
- 4. Station 1009+80 to Station 1010+90 0 to 90 feet LT (Valero Gasoline Station, Site 1773-6, 3118 West 147th Street Posen) non-special waste. Contaminants of concern sampling parameters: BETX and Arsenic.

- 5. Station 1038+25 to Station 1040+00 0 to 120 feet LT (Closed Gasoline Station, Site 1773-14, 2700 West 147th Street, Posen) non-special waste. Contaminants of concern sampling parameters: BETX, SVOCs, and Arsenic.
- 6. Station 6014+00 to Station 6015+50 0 to 80 feet RT (Dixmoor Fruit & Meat Market, Site 1773-26, 14635 Western Avenue Dixmoor) non-special waste. Contaminants of concern sampling parameters: BETX and SVOCs.
- 7. Station 1077+50 to Station 1079+50 0 to 70 feet RT (Former Marathon Station, Site 1773-27, 288 West Sibley Boulevard Harvey) non-special waste. Contaminants of concern sampling parameters: BETX and SVOCs.
- 8. Station 6005+35 to Station 6006+40 0 to 60 feet RT (Harvey Express, Site 1773-33, 14745 Dixie Highway Harvey) non-special waste. Contaminants of concern sampling parameters: BETX and SVOCs.
- 9. Station 1319+80 to Station 1321+00 0 to 160 feet LT (U Pull It, Site 1773-36, 2247 West 141st Street Dixmoor) non-special waste. Contaminants of concern sampling parameters: BETX, SVOCs, Chromium, and Manganese.

Some the soils identified above requiring management as a non-special waste can be managed on-site as fill. Although the soil concentrations exceed a residential property's Tier 1 soil remediation objective for the ingestion exposure pathway, they can be utilized on-site as fill because the roadway is not considered a residential property. All storm sewer excavated soils can be placed back into the excavated trench as trench backfill. If the soils cannot be utilized on-site as fill then they must be managed off-site as a non-special waste. The following areas can be managed on-site as fill.

- Station 1006+60 to Station 1007+75 0 to 100 feet RT (Walgreens, Site 1773-4, 3145 West 147th Street Posen) non-special waste. Contaminants of concern sampling parameters: Arsenic.
- 2. Station 1318+00 to Station 1319+00 0 to 160 feet RT (U Pull It, Site 1773-36, 2247 West 141st Street Dixmoor) non-special waste. Contaminants of concern sampling parameters: Manganese.

Any waste generated as a special waste or a waste not certified as a non-special waste from this project should be manifested off-site using the generator number associated with Cook County. The generator number for Cook County is 0318995023.

The pay item in the Special Provision should be included in the contact plans with the following quantities.

Pay Item Number	Pay Item	Quantity
66900200	NON-SPECIAL WASTE DISPOSAL.	10,707 cubic yards
66900400	SPECIAL WASTE GROUNDWATER DISPOSAL.	9,600 gallons
66900450	SPECIAL WASTE PLANS AND REPORTS.	Lump Sum
66901000	BACKFILL PLUGS.	70 cubic yards
66900530	SOIL DISPOSAL ANALYSIS.	8 Each

Memorandum October 14, 2009 Page 3 of 3

It is the opinion of this office in consultation with Chief Council, that the remedial work be documented for potential illegal trespass action. If you have any questions or comments, please contact Steven Gobelman at 217/785-4246.

Attachment

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cc: Weston Solutions (w/o attachments)
District Land Acquisition (w/o attachments)
District Utilities Coordinator (w/o attachments)

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Appendix C Noise Analysis Results Summary Table

Table C-1: Summary of Existing (2003) and Future (2030) **Traffic Noise Levels**

		IDOT	Tra	Increase		
Receptor	Reference Exhibit	Approach Noise Abatement Criteria	Existing (2003)	No-Action (2030)	Build (2030)	(Build minus Existing)
A-1	Exhibit E-4	71	64	67	66	2
A-2	Exhibit E-4	66	66	69	66	0
A-3	Exhibit E-4	66	63	66	62	-1
A-4	Exhibit E-4	66	65	67	64	-1
A-5	Exhibit E-4	66	64	67	63	-1
A-6	Exhibit E-4	71	65	68	64	-1
A-7	Exhibit E-3	66	67	70	66	-1
A-8	Exhibit E-4	66	63	66	62	-1
A-9	Exhibit E-3	66	62	65	62	0
A-10	Exhibit E-3	66	63	66	64	1
A-11	Exhibit E-3	66	64	66	64	0
A-12	Exhibit E-3	71	64	67	65	1
A-13	Exhibit E-3	66	60	62	62	2
A-14	Exhibit E-3	71	63	65	65	2
A-15	Exhibit E-3	71	64	66	67	3
A-16	Exhibit E-3	66	60	62	62	2
A-17	Exhibit E-3	71	62	64	65	3
A-18	Exhibit E-3	71	59	61	61	2
A-19	Exhibit E-3	71	63	63	63	0
A-20	Exhibit E-3	66	58	59	60	2
A-21	Exhibit E-3	71	65	66	64	-1
A-22	Exhibit E-3	66	58	59	60	2
A-23	Exhibit E-3	66	60	61	60	0
A-24	Exhibit E-3	66	63	63	62	-1
A-25	Exhibit E-3	66	59	59	59	0
B-1	Exhibit E-4	66	62	63	65	3
B-2	Exhibit E-4	71	62	63	68	6
B-3	Exhibit E-4	66	61	63	65	4
B-4	Exhibit E-4	66	59	61	63	4
B-5	Exhibit E-4	66	60	62	62	2
B-6	Exhibit E-4	66	62	64	65	3
B-7	Exhibit E-4	66	61	63	64	3
B-8	Exhibit E-4	66	65	66	68	3
B-9	Exhibit E-4	66	63	65	66	3
B-10	Exhibit E-4	66	61	63	63	2
B-11	Exhibit E-4	66	60	62	63	3
B-12	Exhibit E-4	66	62	64	65	3
B-13	Exhibit E-4	66	61	62	62	1
B-14	Exhibit E-4	66	65	66	66	1
B-15	Exhibit E-4	66	60	62	61	1
B-16	Exhibit E-4	66	63	65	63	0
B-17	Exhibit E-4	66	62	64	63	1
B-18	Exhibit E-4	66	66	68	66	0
B-19	Exhibit E-4	66	61	63	63	2
B-20	Exhibit E-3	66	64	66	65	1
B-21	Exhibit E-3	71	66	68	66	0
B-22	Exhibit E-3	71	62	64	64	2
B-23	Exhibit E-3	71	61	62	63	2

Note: The modeled traffic noise levels are a result of noise generated from 1-294, 1-57 and 147th Street. Other major roadways, i.e. Dixie Highway, Kedzie Avenue, were not included in the model. Train noise was not included in the model either. Shaded areas represent traffic noise levels that approach (within 1 dBA) or exceed the NAC.

* - Properties that will be relocated by the Interchange Project. Refer Environmental Assessment Report for final list.

Table C-1: Summary of Existing (2003) and Future (2030)
Traffic Noise Levels (Continued)

	IDOT Traffic Noise Level					
		IDOT Approach	Increase			
		Approach Noise				(Build
	Reference	Abatement	Existing	No-Action	Build	minus
Receptor	Exhibit	Criteria	(2003)	(2030)	(2030)	Existing)
B-24	Exhibit E-4	66	60	62	63	3
B-25	Exhibit E-4	66	62	63	64	2
B-26	Exhibit E-4	66	61	62	62	1
B-27	Exhibit E-4	66	64	67	68	4
B-28	Exhibit E-4	66	61	62	63	2
B-29	Exhibit E-4	66	62	64	65	3
C-1	Exhibit E-3	66	61	62	61	0
C-2	Exhibit E-3	66	64	65	63	-1
C-3	Exhibit E-3	66	59	60	60	1
C-4	Exhibit E-3	71	63	64	63	0
C-5	Exhibit E-3	71	66	67	66	0
C-6	Exhibit E-3	71	57	58	60	3
C-7	Exhibit E-3	71	65	67	67	2
C-8	Exhibit E-3	71	64	67	66	2
C-9	Exhibit E-3	66	64	67	67	3
C-10	Exhibit E-3, E-7	66	63	66	66	3
C-11	Exhibit E-3, E-7	66	60	63	63	3
C-12	Exhibit E-3, E-7	66	63	67	68	5
C-13	Exhibit E-3, E-7	66	61	64	64	3
C-14	Exhibit E-3, E-7	66	61	63	65	4
C-15	Exhibit E-3, E-7	66	63	66	67	4
C-16	Exhibit E-3, E-7	66	66	64	68	2
C-17	Exhibit E-3, E-7	66	64	64	67	3
C-18	Exhibit E-3, E-7	66	63	63	66	3
C-19	Exhibit E-3, E-7	66	64	61	67	3
C-20	Exhibit E-3, E-7	66	66	62	69	3
C-21	Exhibit E-3, E-6	66	64	61	67	3
C-22	Exhibit E-6	66	72	64	*	3
C-23	Exhibit E-6	66	64	60	68	4
C-24	Exhibit E-6	66	62	59	65	3
C-25	Exhibit E-6	66	71	63	*	0
C-26	Exhibit E-6	66	64	60	68	4
C-27	Exhibit E-6	66	68	63	70	2
C-28	Exhibit E-6	66	72	64	72	0
C-29	Exhibit E-6	71	70	70	71	1
C-30	Exhibit E-6	66	68	65	68	0
C-31	Exhibit E-6	66	72	71	72	0
C-32	Exhibit E-6	66	75	73	*	-2
C-33	Exhibit E-6	66	70	63	72	2
C-34	Exhibit E-6	66	62	59	69	7
C-35	Exhibit E-6	66	66	61	71	5
C-36	Exhibit E-3, E-6	66	67	62	71	4
C-37	Exhibit E-3, E-6	66	67	62	70	3
C-38	Exhibit E-3, E-6	66	71	64	*	3
C-39	Exhibit E-3, E-6	66	63	61	66	3
C-40	Exhibit E-3, E-6	66	66	62	68	2
C-41	Exhibit E-3, E-6	66	65	62	68	3
C-42	Exhibit E-3, E-6	66	68	64	70	2
C-43	Exhibit E-3, E-6	66	68	64	7 1	3

Note: The modeled traffic noise levels are a result of noise generated from I-294, I-57 and 147th Street. Other major roadways, i.e. Dixie Highway, Kedzie Avenue, were not included in the model. Train noise was not included in the model either. Shaded areas represent traffic noise levels that approach (within 1 dBA) or exceed the NAC. * - Properties that will be relocated by the Interchange Project. Refer Environmental Assessment Report for final list.

Table C-1: Summary of Existing (2003) and Future (2030) **Traffic Noise Levels (Continued)**

		IDOT	Tra			
		Approach	Transcript Beyon			Increase
	D 4	Noise				(Build
Receptor	Reference Exhibit	Abatement	Existing	No-Action	Build	minus Existing)
		Criteria	(2003)	(2030)	(2030)	_
C-44	Exhibit E-3, E-6	66	63	67	68	5
C-45	Exhibit E-3, E-6	66	62	66	66	4
C-46	Exhibit E-3, E-6	66	61	64	64	3
D-1	Exhibit E-3	66	59	60	62	3
D-2	Exhibit E-3	66	58	59	62	4
D-3	Exhibit E-3	66	57	58	61	4
D-4	Exhibit E-3	66	57	58	61	4
D-5	Exhibit E-3	66	60	62	63	3
D-6	Exhibit E-3	66	60	62	63	3
D-7	Exhibit E-3	66	59	61	63	4
D-8	Exhibit E-3	66	59	60	62	3
D-9	Exhibit E-3	71	63	65	66	3
E-1	Exhibit E-2	71	61	64	63	2
E-2	Exhibit E-2	66	58	61	62	4
E-3	Exhibit E-2	66	60	63	65	5
E-4	Exhibit E-2	66	57	59	61	4
E-5	Exhibit E-2	66	59	61	64	5
E-6	Exhibit E-2	66	67	71	72	5
E-7	Exhibit E-2	66	59	63	65	6
E-8	Exhibit E-2	66	57	61	63	6
E-9	Exhibit E-1	66	60	63	63	3
E-10	Exhibit E-1	66	69	71	70	1
E-11	Exhibit E-1	66	62	64	64	2
E-12	Exhibit E-1	66	66	68	67	1
E-13	Exhibit E-1	66	60	63	63	3
E-14	Exhibit E-1	66	62	64	64	2
E-15	Exhibit E-1	66	64	66	66	2
E-16	Exhibit E-1	66	54	56	56	2
E-17	Exhibit E-1	66	69	71	70	1
E-18	Exhibit E-1	66	70	73	71	1
F-1	Exhibit E-1	66	69	70	70	1
F-2	Exhibit E-1	66	67	68	67	0
F-3	Exhibit E-1	66	65	66	65	0
F-4	Exhibit E-1	66	61	62	61	0
F-5	Exhibit E-1	66	59	62	61	2
F-6	Exhibit E-1	66	59	61	61	2
F-7	Exhibit E-2	66	62	64	65	3
F-8	Exhibit E-2	66	60	62	63	3
F-9	Exhibit E-2	66	63	65	66	3
F-10	Exhibit E-2	66	59	61	63	4
F-11	Exhibit E-2	66	59	61	63	4
F-12	Exhibit E-2	66	64	65	66	2
F-13	Exhibit E-2	66	59	61	63	4
F-14	Exhibit E-7	66	63	64	70	7
F-15	Exhibit E-7	66	64	66	66	2
F-16	Exhibit E-8	66	66	68	68	2

Note: The modeled traffic noise levels are a result of noise generated from 1-294, 1-57 and 147th Street. Other major roadways, i.e. Dixie Highway, Kedzie Avenue, were not included in the model. Train noise was not included in the model either. Shaded areas represent traffic noise levels that approach (within 1 dBA) or exceed the NAC.
*- Properties that will be relocated by the Interchange Project. Refer Environmental Assessment Report for final list.

Table C-1: Summary of Existing (2003) and Future (2030) **Traffic Noise Levels (Continued)**

		IDOT	Tra			
		Approach				Increase (Build
	Reference	Noise	Evicting	No-Action	Build	minus
Receptor	Exhibit	Abatement Criteria	Existing (2003)	(2030)	(2030)	Existing)
F-17	Exhibit E-2	66	67	68	67	0
G-1	Exhibit E-1	66	69	71	70	1
G-2	Exhibit E-1	66	65	67	66	1
G-3	Exhibit E-1	66	63	65	64	1
G-4	Exhibit E-1	66	60	62	62	2
G-5	Exhibit E-1	66	59	62	61	2
G-6	Exhibit E-1	66	61	63	62	1
G-7	Exhibit E-1	66	59	61	62	3
H-1	Exhibit E-1	66	60	61	63	3
H-2	Exhibit E-1	66	65	66	67	2
H-3	Exhibit E-1	66	60	62	63	3
H-4	Exhibit E-1	66	62	64	64	2
H-5	Exhibit E-1	71	70	71	70	0
H-6	Exhibit E-1	66	65	66	67	2
H-7	Exhibit E-1	66	60	61	63	3
I-1	Exhibit E-5	66	72	62	65	-7
I-2	Exhibit E-5	66	69	60	65	-4
I-3	Exhibit E-5	66	72	62	64	-8
I-4	Exhibit E-5	66	69	60	64	-5
I-5	Exhibit E-5	66	65	57	63	-2
I-6	Exhibit E-5	66	65	58	61	-4
I-7	Exhibit E-5	66	71	62	62	-9
I-8	Exhibit E-5	66	69	60	62	-7
I-9	Exhibit E-5	66	71	62	61	-10
I-10	Exhibit E-5	66	68	59	61	-7
I-11	Exhibit E-5	66	70	61	61	-9
I-12	Exhibit E-5	66	68	60	61	-7
I-13	Exhibit E-5	66	66	58	61	-5
I-14	Exhibit E-5	66	69	60	*	-
I-15	Exhibit E-5	66	68	59	64	-4
I-16	Exhibit E-5	66	65	59	64	-1
I-17	Exhibit E-5	66	67	67	65	-2
I-18	Exhibit E-6	66	67	67	*	-
I-19	Exhibit E-6	66	71	70	*	_
I-20	Exhibit E-6	66	69	68	66	-2
I-21	Exhibit E-6	66	68	67	67	-1
I-22	Exhibit E-6	66	63	60	67	3
I-23	Exhibit E-6	66	64	59	66	2
I-24	Exhibit E-6	66	61	58	63	2
I-25	Exhibit E-6	66	71	64	*	_
I-26	Exhibit E-6	66	65	61	66	1
I-27	Exhibit E-6	66	69	62	69	-1
I-28	Exhibit E-6	66	71	63	*	
I-29	Exhibit E-6	66	70	63	67	-3
I-30	Exhibit E-6	66	69	65	68	-1
I-31	Exhibit E-6	66	73	71	*	-
I-32	Exhibit E-6	66	73	72	*	-
I-33	Exhibit E-6	71	70	70	70	0

Note: The modeled traffic noise levels are a result of noise generated from 1-294, 1-57 and 147th Street. Other major roadways, i.e. Dixie Highway, Kedzie Avenue, were not included in the model. Train noise was not included in the model either. Shaded areas represent traffic noise levels that approach (within 1 dBA) or exceed the NAC.

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Table C-1: Summary of Existing (2003) and Future (2030) **Traffic Noise Levels (Continued)**

		IDOT	Traffic Noise Level			
		Approach				Increase
	Reference	Noise	T	3 7 4 4	D 11.1	(Build minus
Receptor	Exhibit	Abatement Criteria	Existing	No-Action	Build	Existing)
I-34	Exhibit E-6	66	(2003) 63	(2030) 62	(2030)	0
I-34	Exhibit E-6	66	65	64	65	0
J-1	Exhibit E-3, E-7	66	66	67	65	
J-2	Exhibit E-3, E-7	66	64	65	65	1 1
J-3	Exhibit E-3, E-7	66	63	64	64	1
J-4	Exhibit E-3, E-7	66	61	62	63	2
J-5	Exhibit E-3, E-7	66	66	65	65	-1
J-6	Exhibit E-3, E-7	66	64	63	64	0
J-7	Exhibit E-3, E-7	66	66	64	65	-1
J-8	Exhibit E-3, E-7	66	64	63	64	0
J-9	Exhibit E-3, E-7	66	65	62	65	0
J-10	Exhibit E-3, E-7	66	68	64	68	0
J-11	Exhibit E-3, E-7	66	69	64	70	1
J-12	Exhibit E-3, E-7	66	66	62	67	1
J-13	Exhibit E-7	66	64	61	65	1
J-14	Exhibit E-7	66	71	64	71	0
J-15	Exhibit E-7	66	67	63	69	2
J-16	Exhibit E-7	66	65	62	66	1
J-17	Exhibit E-7	66	73	65	74	1
J-18	Exhibit E-7	66	68	63	69	1
J-19	Exhibit E-7	66	66	63	67	1
J-20	Exhibit E-7	66	69	68	70	1
K-1	Exhibit E-5	66	65	60	61	-4
K-2	Exhibit E-5	66	63	58	61	-2
K-3	Exhibit E-5	66	68	67	61	-7
K-4	Exhibit E-5	66	68	65	60	-8
K-5	Exhibit E-5	66	66	63	59	-7
K-6	Exhibit E-5	66	68	66	62	-6
K-7	Exhibit E-5	66	67	65	61	-6
K-8	Exhibit E-5	66	67	65	61	-6
K-9	Exhibit E-5	66	70	72	74	4
K-10	Exhibit E-5, E-6	66	69	69	69	0
K-11	Exhibit E-6	66	65	66	69	4
K-12	Exhibit E-6	66	62	57	68	6
K-13	Exhibit E-6	66	58	55	65	7
K-14	Exhibit E-6	66	59	55	66	7
K-15	Exhibit E-6	66	56	54	63	7
K-16	Exhibit E-6	66	57	55	64	7
K-17	Exhibit E-6	66	57	55	62	5
K-18	Exhibit E-6	66	62	61	66	3
K-19	Exhibit E-6	66	68	63	69	1
K-20	Exhibit E-6	66	66	63	68	2
K-21	Exhibit E-6	66	71	65	71	0
K-22	Exhibit E-6	66	63	61	65	2
K-23	Exhibit E-6	66	65	64	67	2
K-24	Exhibit E-6	66	69	67	69	-1
K-25	Exhibit E-6	71	68	68	67	-1

Note: The modeled traffic noise levels are a result of noise generated from 1-294, 1-57 and 147th Street. Other major roadways, i.e. Dixie Highway, Kedzie Avenue, were not included in the model. Train noise was not included in the model either. Shaded areas represent traffic noise levels that approach (within 1 dBA) or exceed the NAC.


* - Properties that will be relocated by the Interchange Project. Refer Environmental Assessment Report for final list.


Table C-1: Summary of Existing (2003) and Future (2030) **Traffic Noise Levels (Continued)**


		IDOT	Traf			
		Approach				Increase
	Deference	Noise				(Build
Receptor	Reference Exhibit	Abatement	Existing	No-Action	Build	minus Existing)
K-26	Exhibit E-6	Criteria 66	(2003) 67	(2030)	(2030)	
K-20 K-27	Exhibit E-6	66	56	68 56	65	-1
K-27 K-28	Exhibit E-6	66	50 	56	65	9
K-28 K-29	Exhibit E-6	66	<u>57</u> 58	56	65	8 7
K-29 K-30	Exhibit E-6	66	62	57	63	
[Exhibit E-6	66	65	{	64	6
K-31	Exhibit E-6	66	64	58 58	69	6
K-32	}	 		<u> </u>		4
K-33	Exhibit E-6	66	67	60 59	71	
K-34	Exhibit E-6	66 66	67 66		71 70	4
K-35	Exhibit E-6	66	65	58	69	4
K-36	Exhibit E-6	{{		61		4
K-37	Exhibit E-6	66	68	63	70	2
K-38	Exhibit E-6	66	60	56	67	7
K-39	Exhibit E-6	66	63	58	69	6
K-40	Exhibit E-6	66	59	57	66	7
K-41	Exhibit E-6	66	58	57	64	7
K-42	Exhibit E-6	66	58	56	66	8
L-1	Exhibit E-6	66	65	64	65	0
L-2	Exhibit E-6	71	69	70	68	-1
L-3	Exhibit E-6	66	68	66	68	0
L-4	Exhibit E-6	66	73	68	71	-2
L-5	Exhibit E-6	66	70	65	71	-1
L-6	Exhibit E-6	66	69	63	69	0
L-7	Exhibit E-6	66	63	60	65	2
L-8	Exhibit E-6	66	64	60	66	2
L-9	Exhibit E-6	66	68	63	69	1
L-10	Exhibit E-6	66	71	64	72	1
L-11	Exhibit E-6	66	69	63	71	2
L-12	Exhibit E-6	66	65	60	68	3
L-13	Exhibit E-6	66	62	58	65	3
L-14	Exhibit E-6	66	68	62	69	11
L-15	Exhibit E-6	66	70	64	72	2
L-16	Exhibit E-6	66	63	59	66	3
L-17	Exhibit E-6	66	67	62	69	2
L-18	Exhibit E-6	66	71	64	74	3
L-19	Exhibit E-6	66	62	58	66	4
L-20	Exhibit E-6	66	65	60	68	3
L-21	Exhibit E-6	66	69	63	72	3
L-22	Exhibit E-6	66	67	62	70	3
L-23	Exhibit E-6	66	63	59	66	3
L-24	Exhibit E-3, E-7	66	65	61	68	3
L-25	Exhibit E-3, E-7	66	60	57	64	4
L-26	Exhibit E-3, E-7	66	62	59	65	3
L-27	Exhibit E-7	66	67	62	71	4
L-28	Exhibit E-7	66	65	61	68	3


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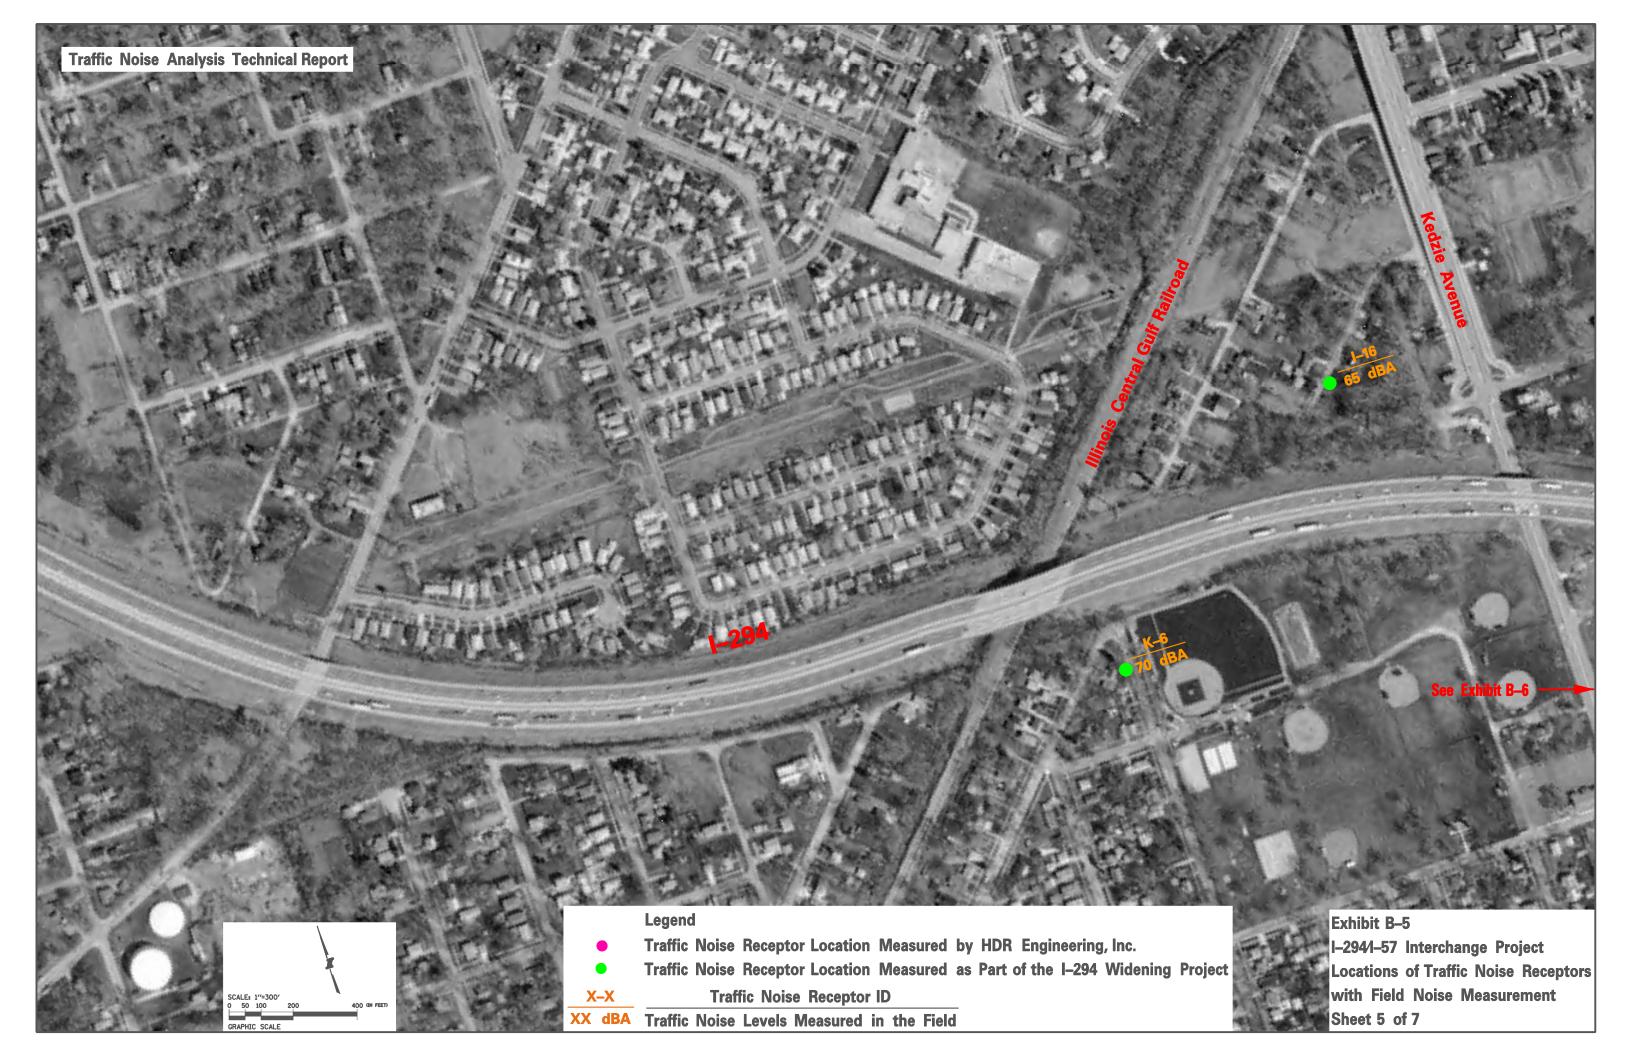
* - Properties that will be relocated by the Interchange Project. Refer Environmental Assessment Report for final li



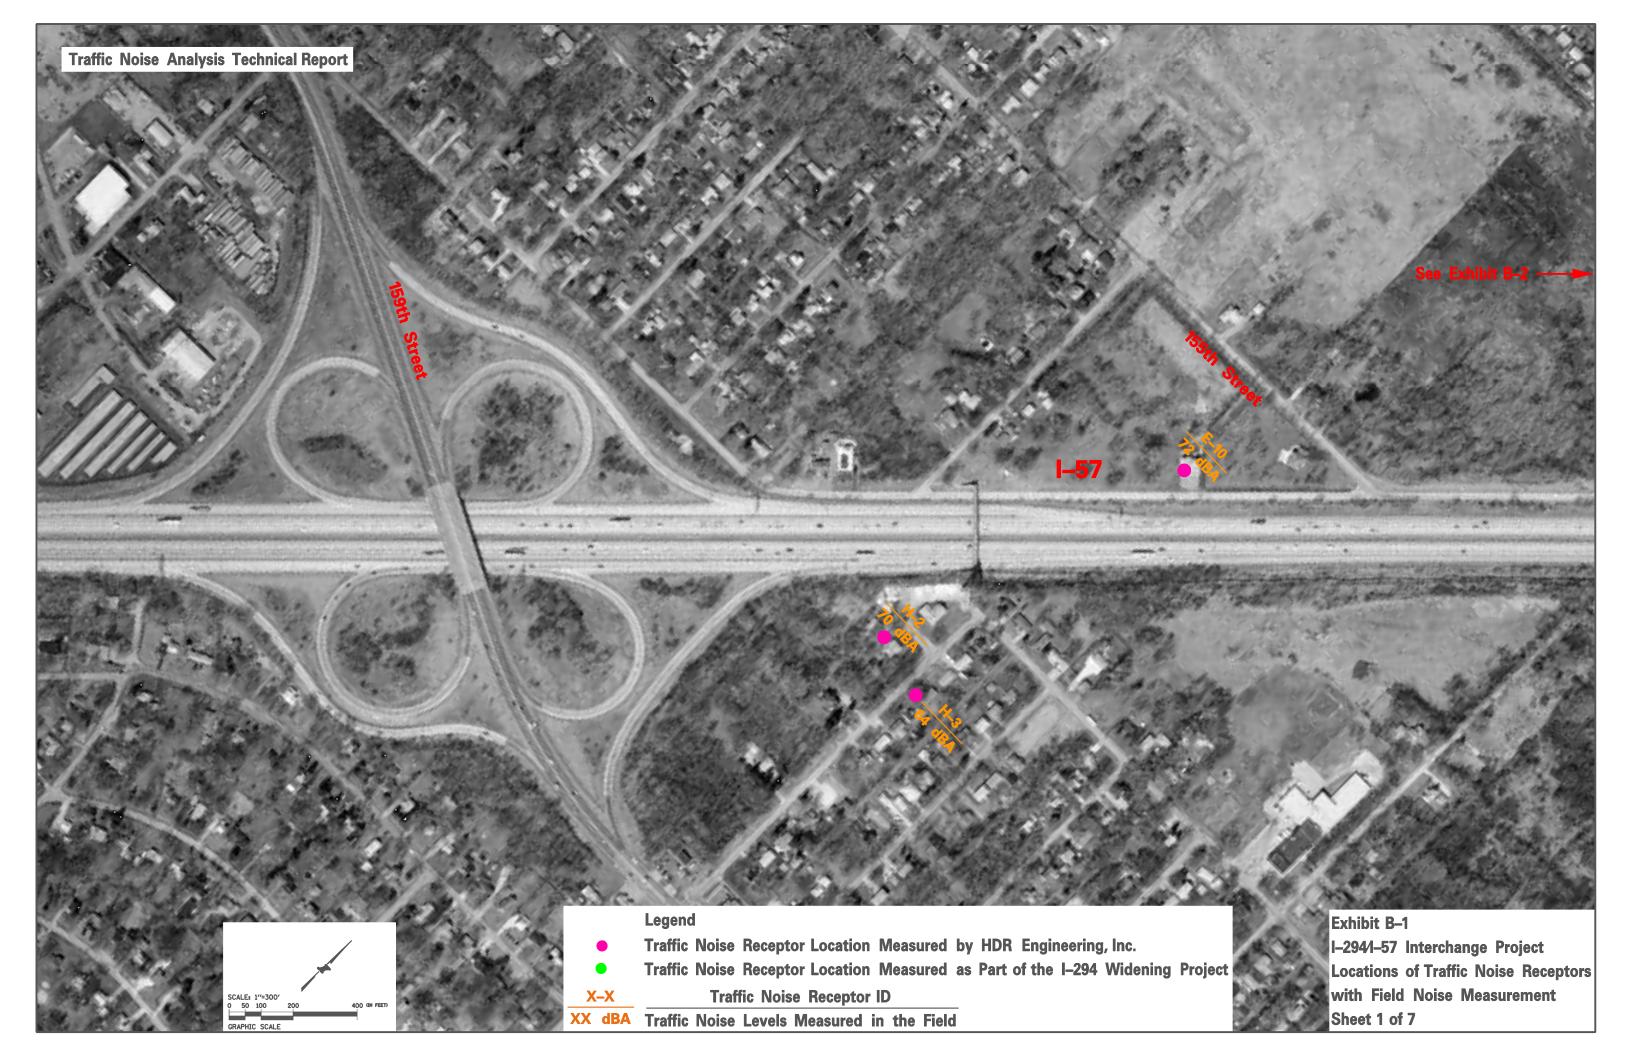

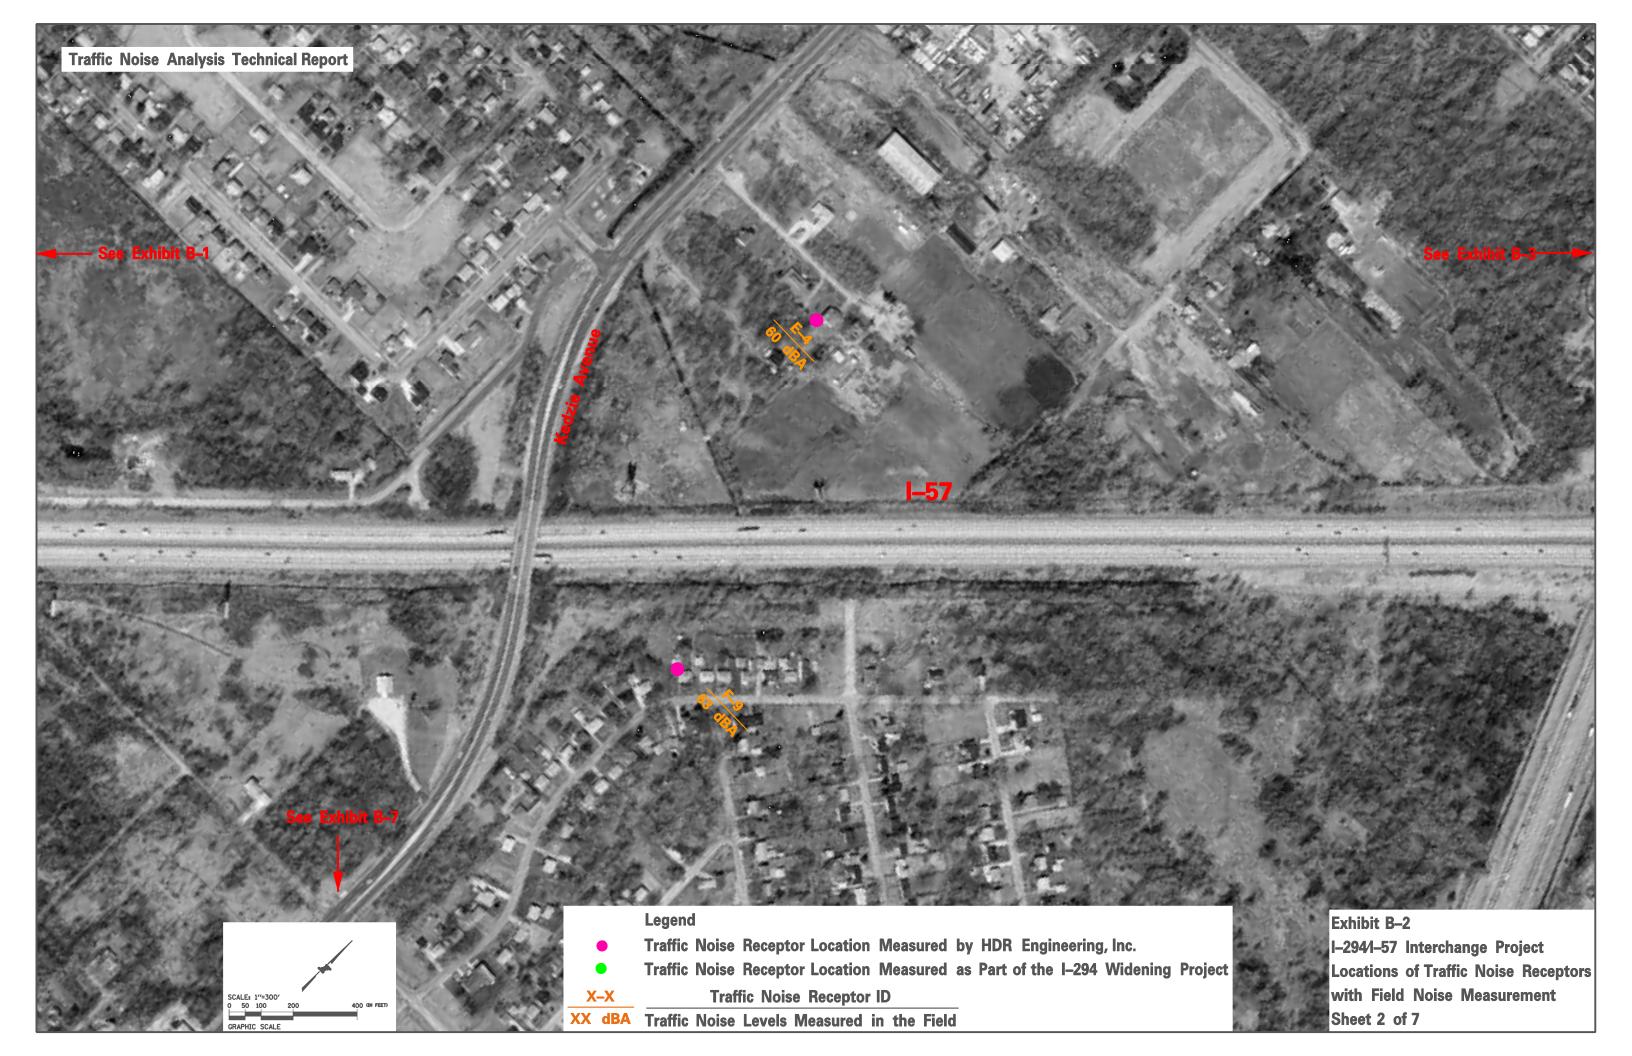


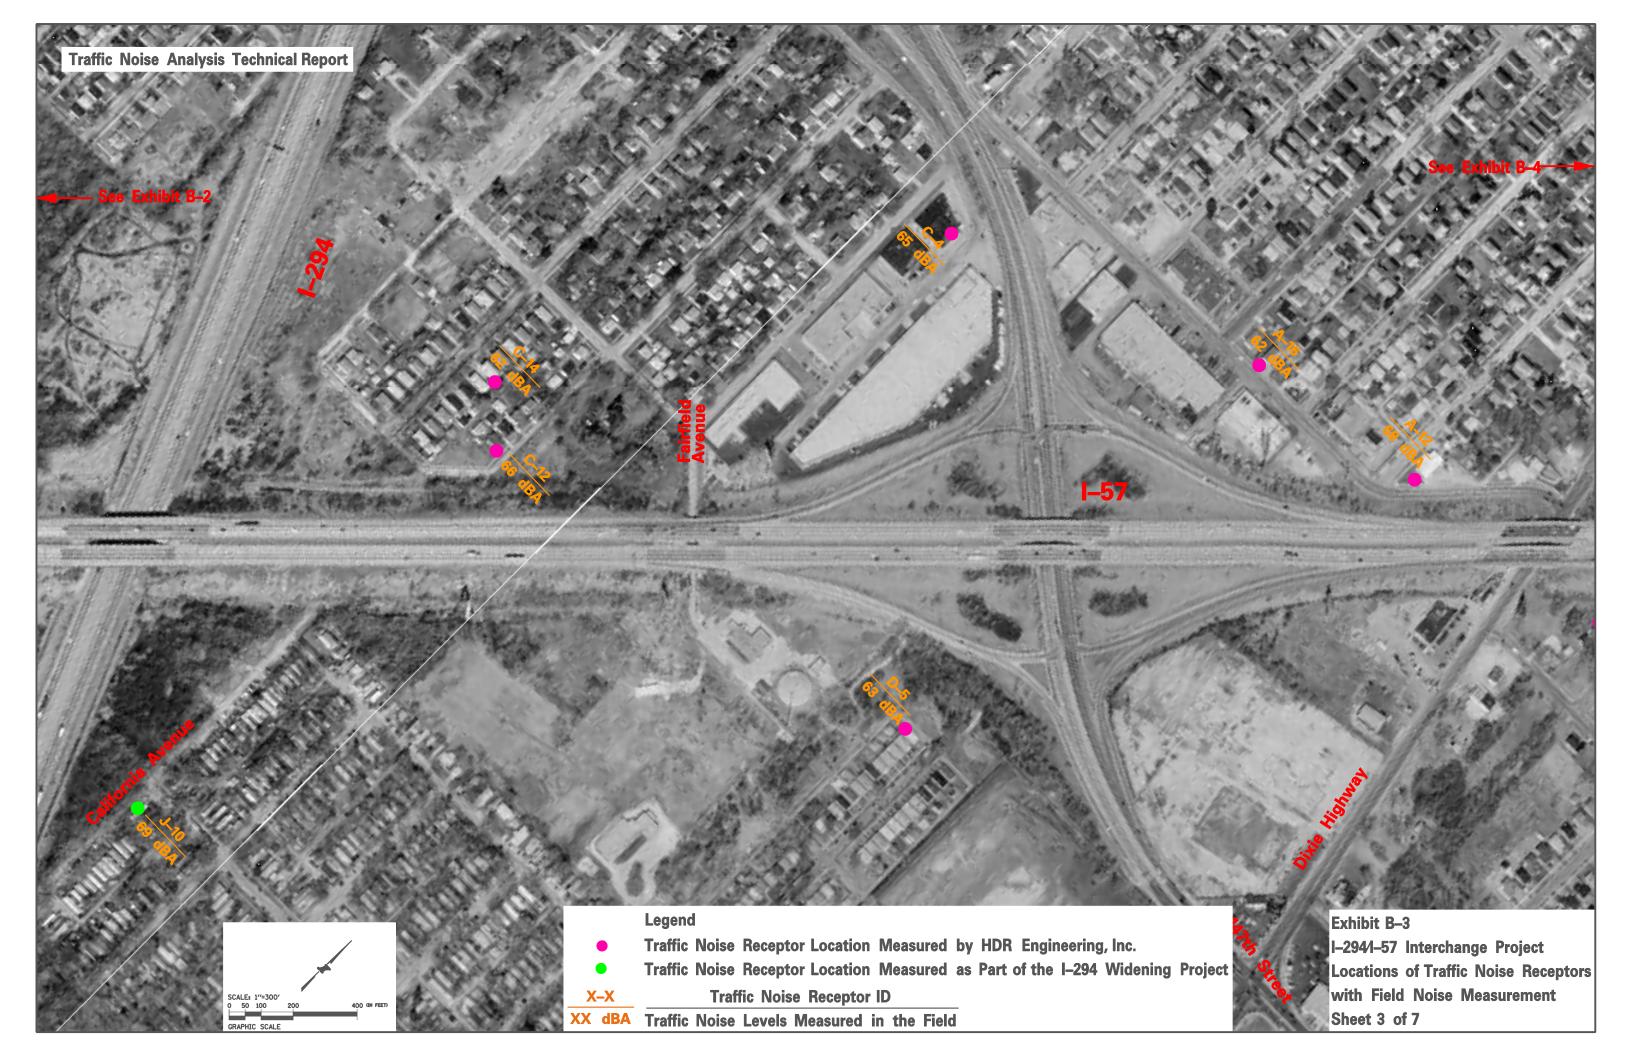


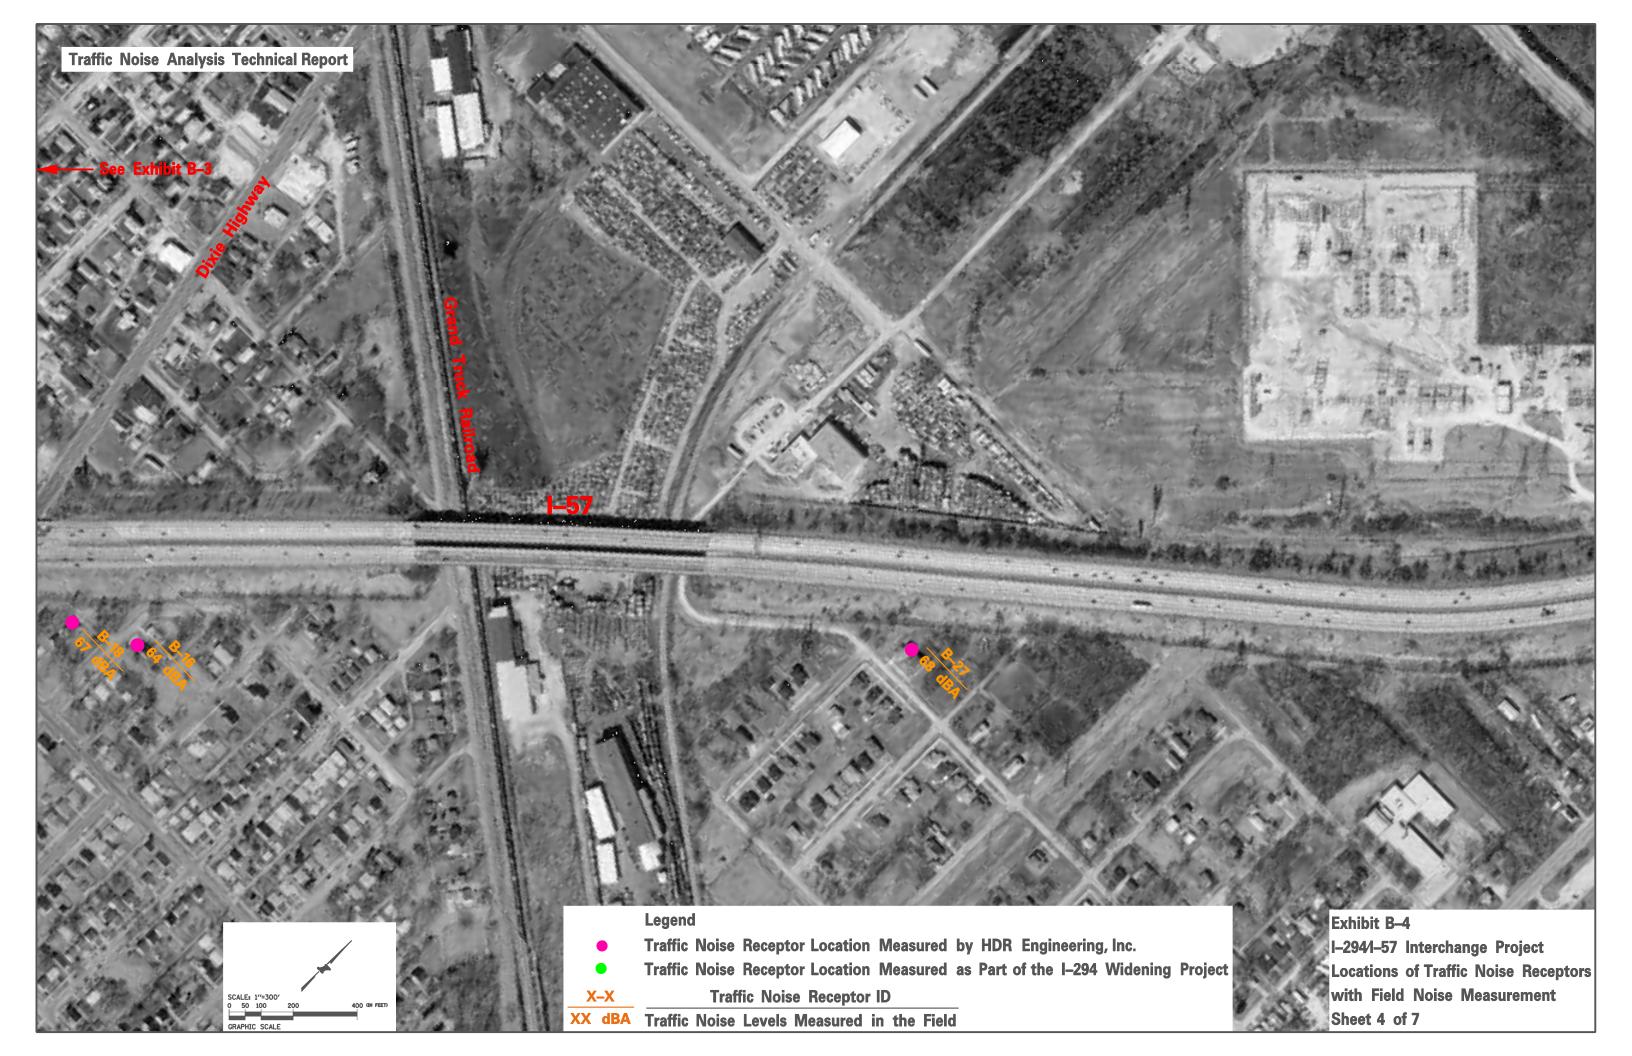








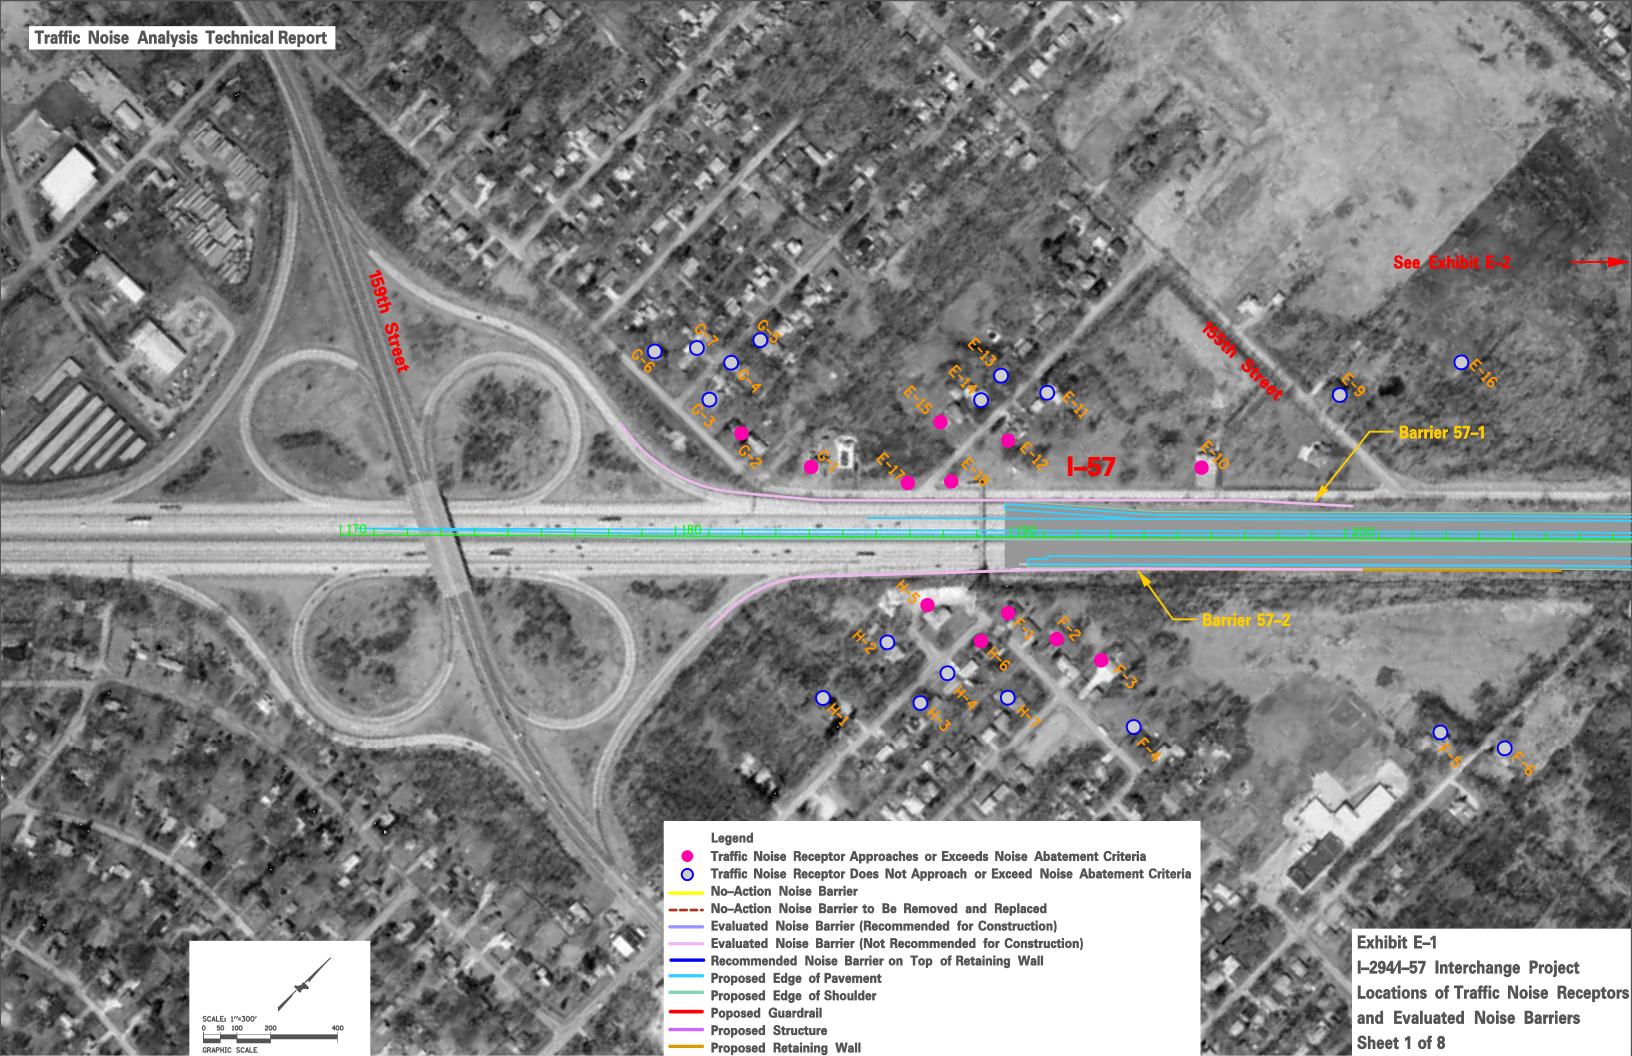


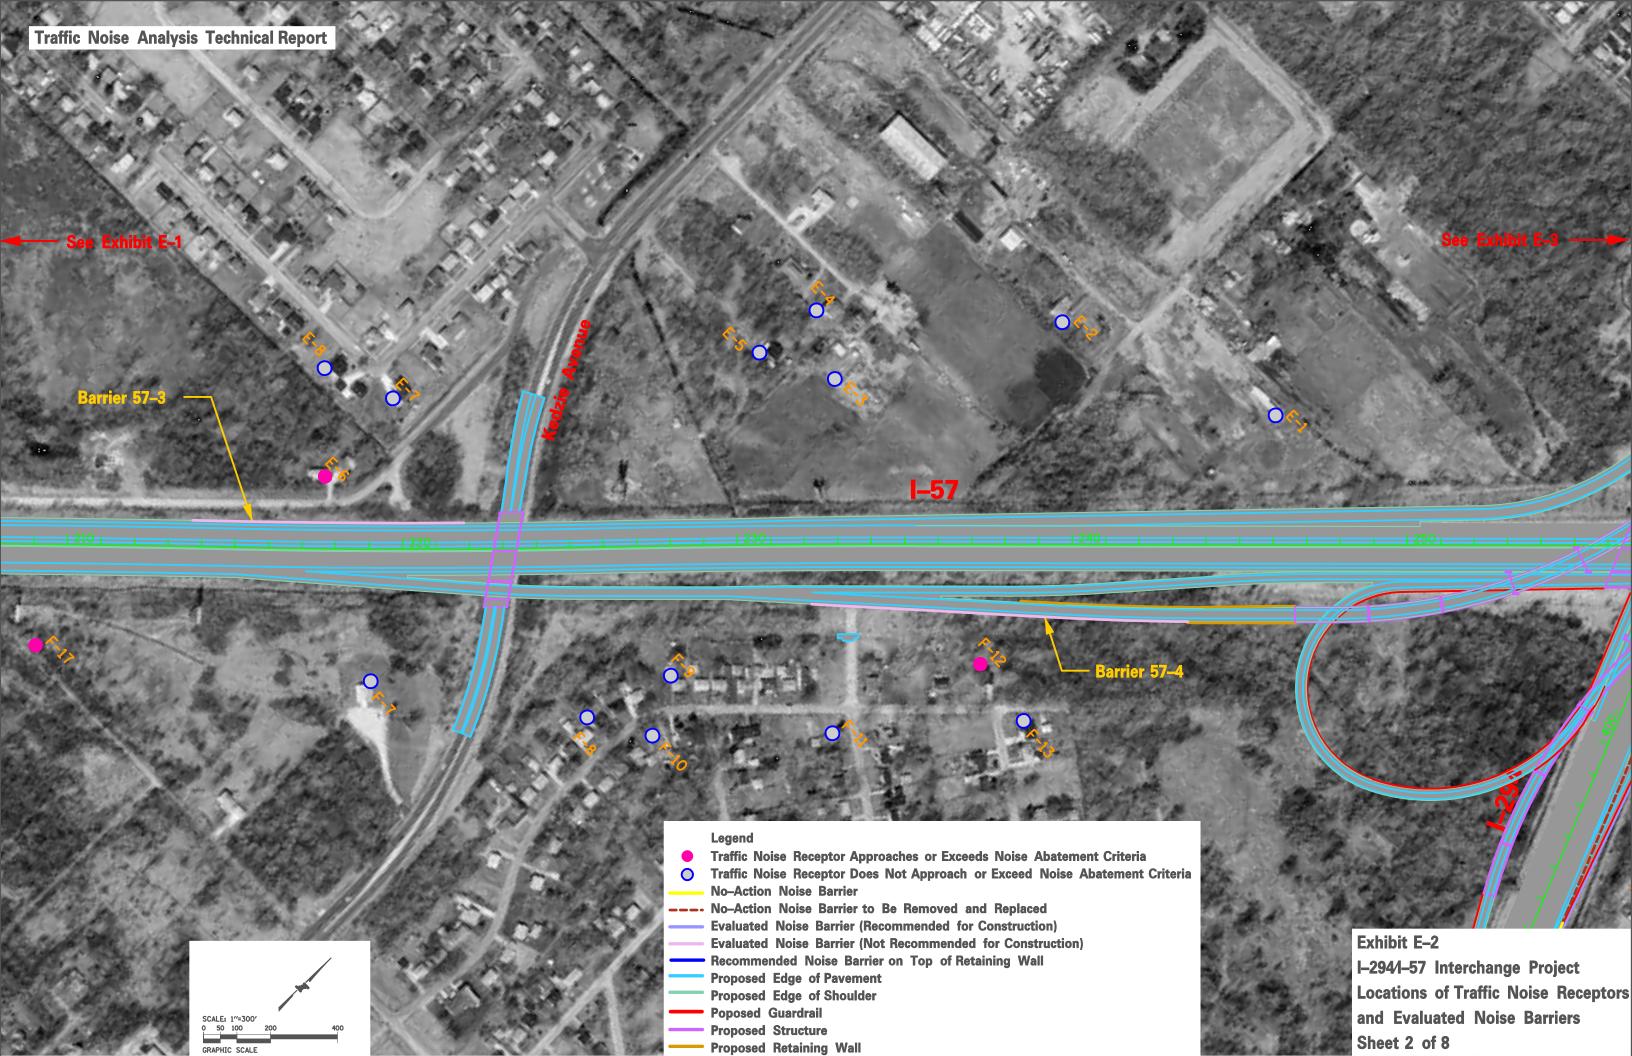


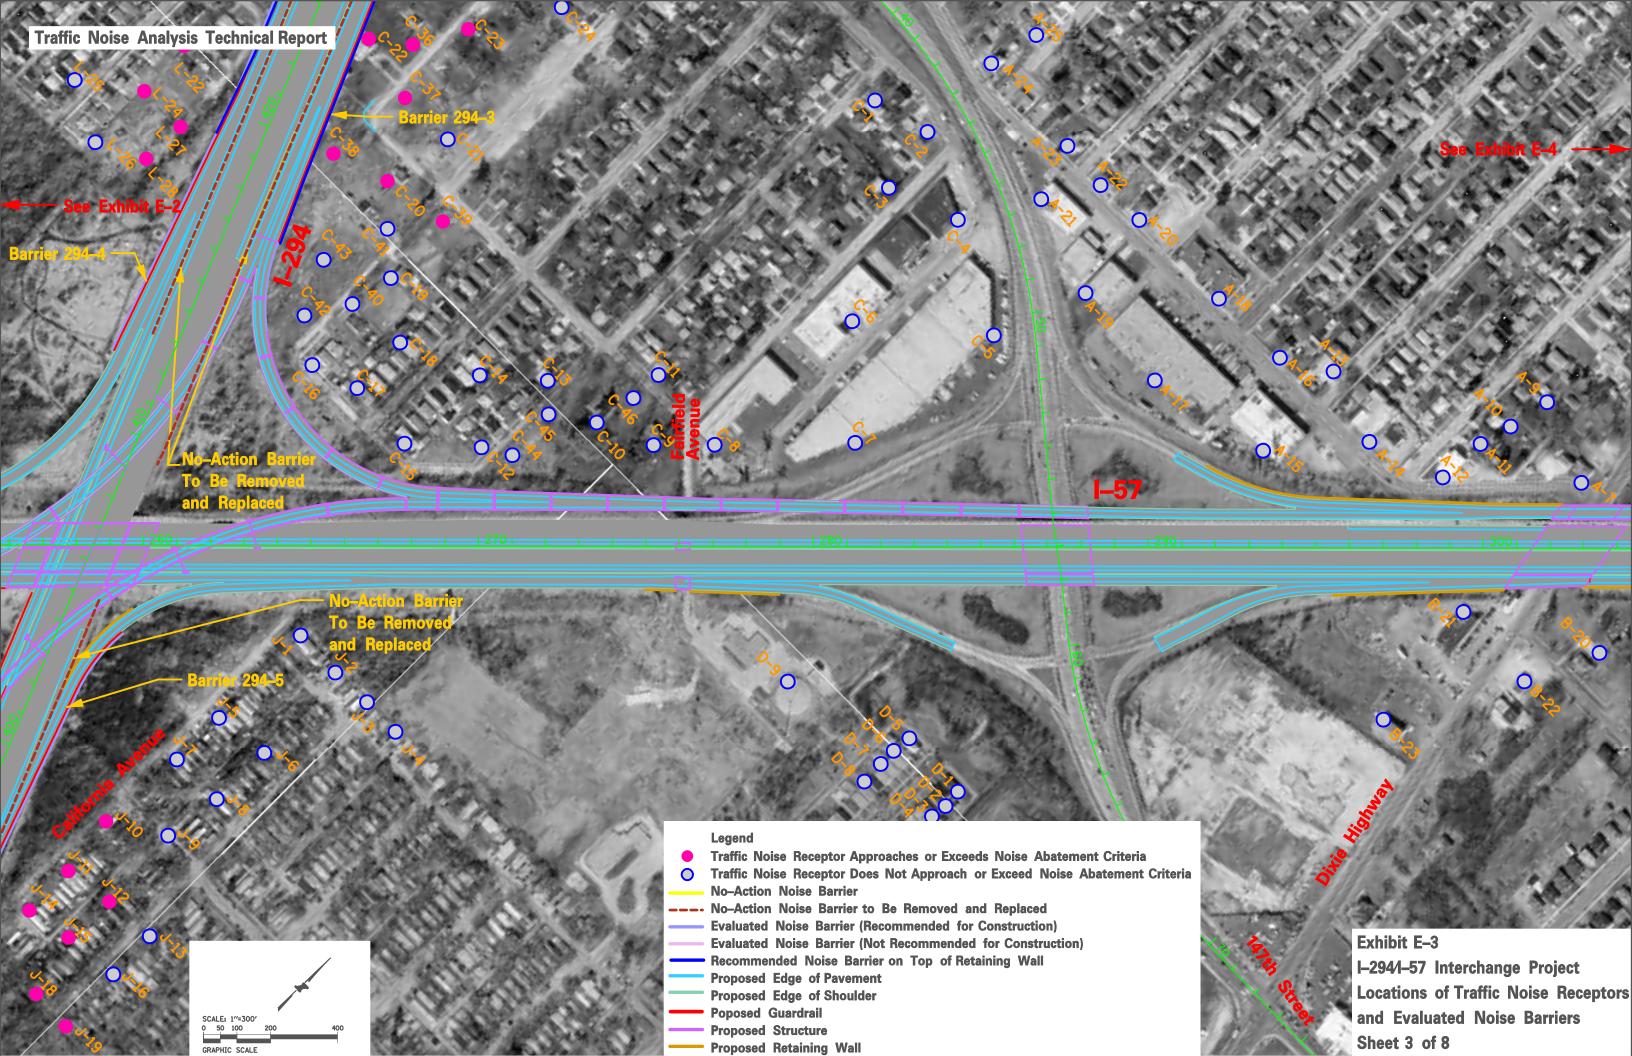


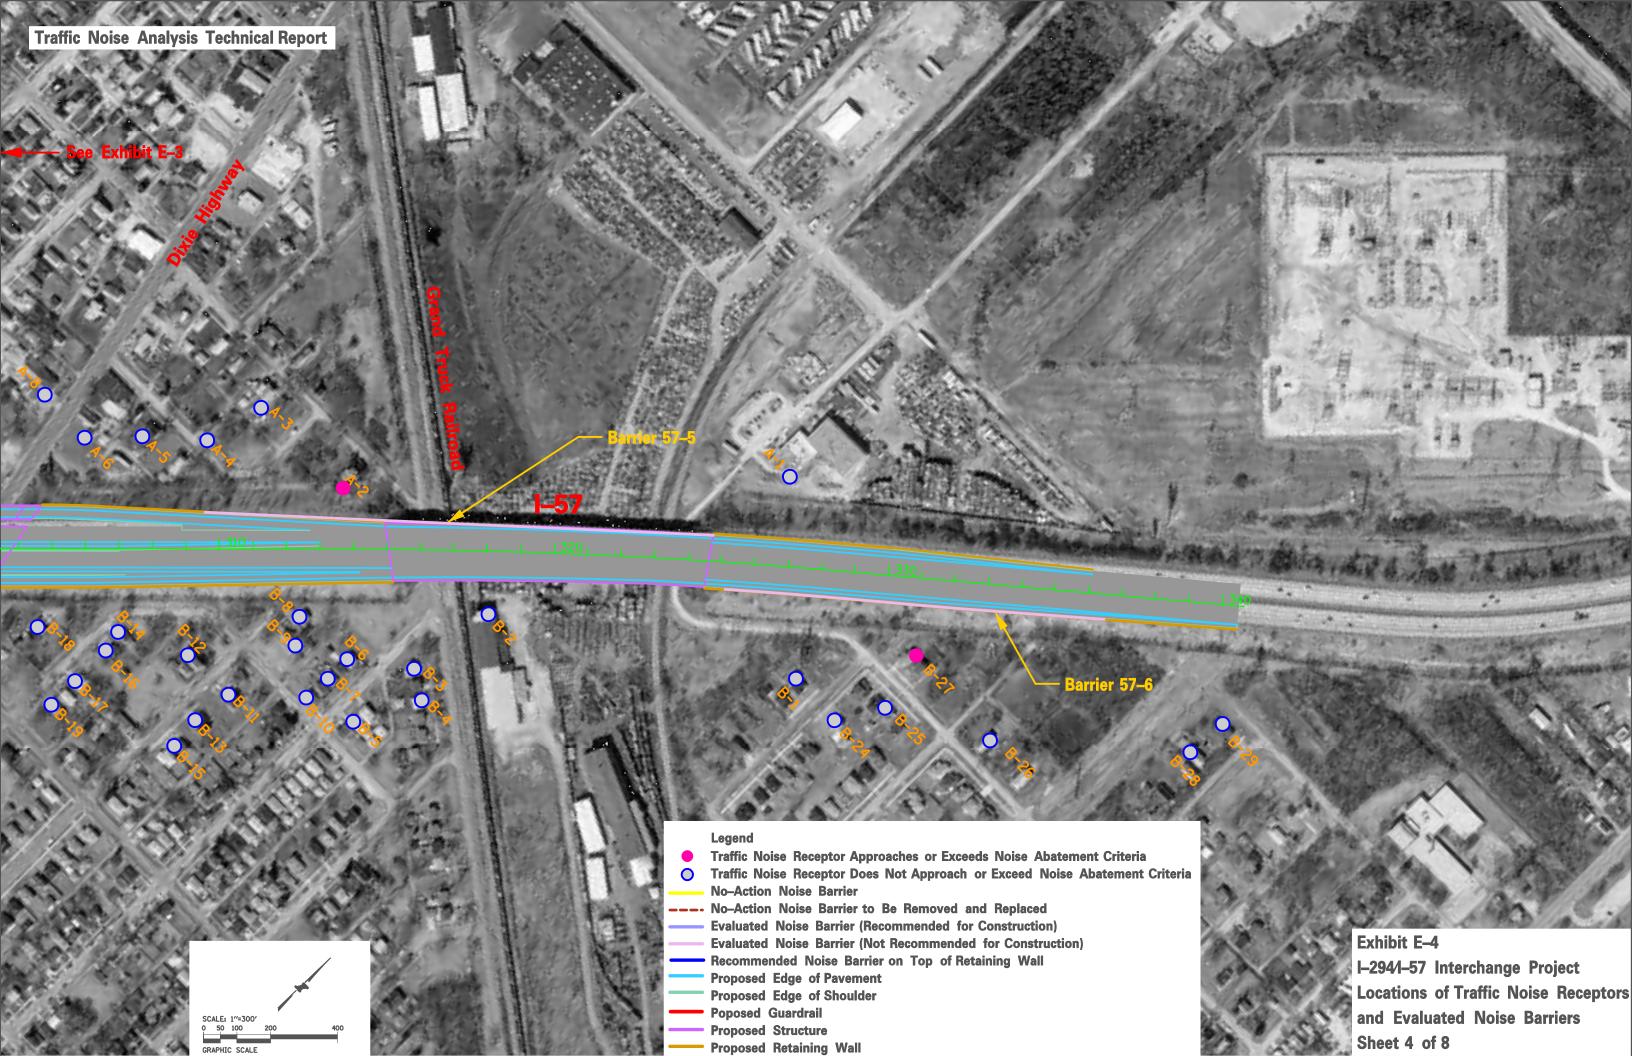

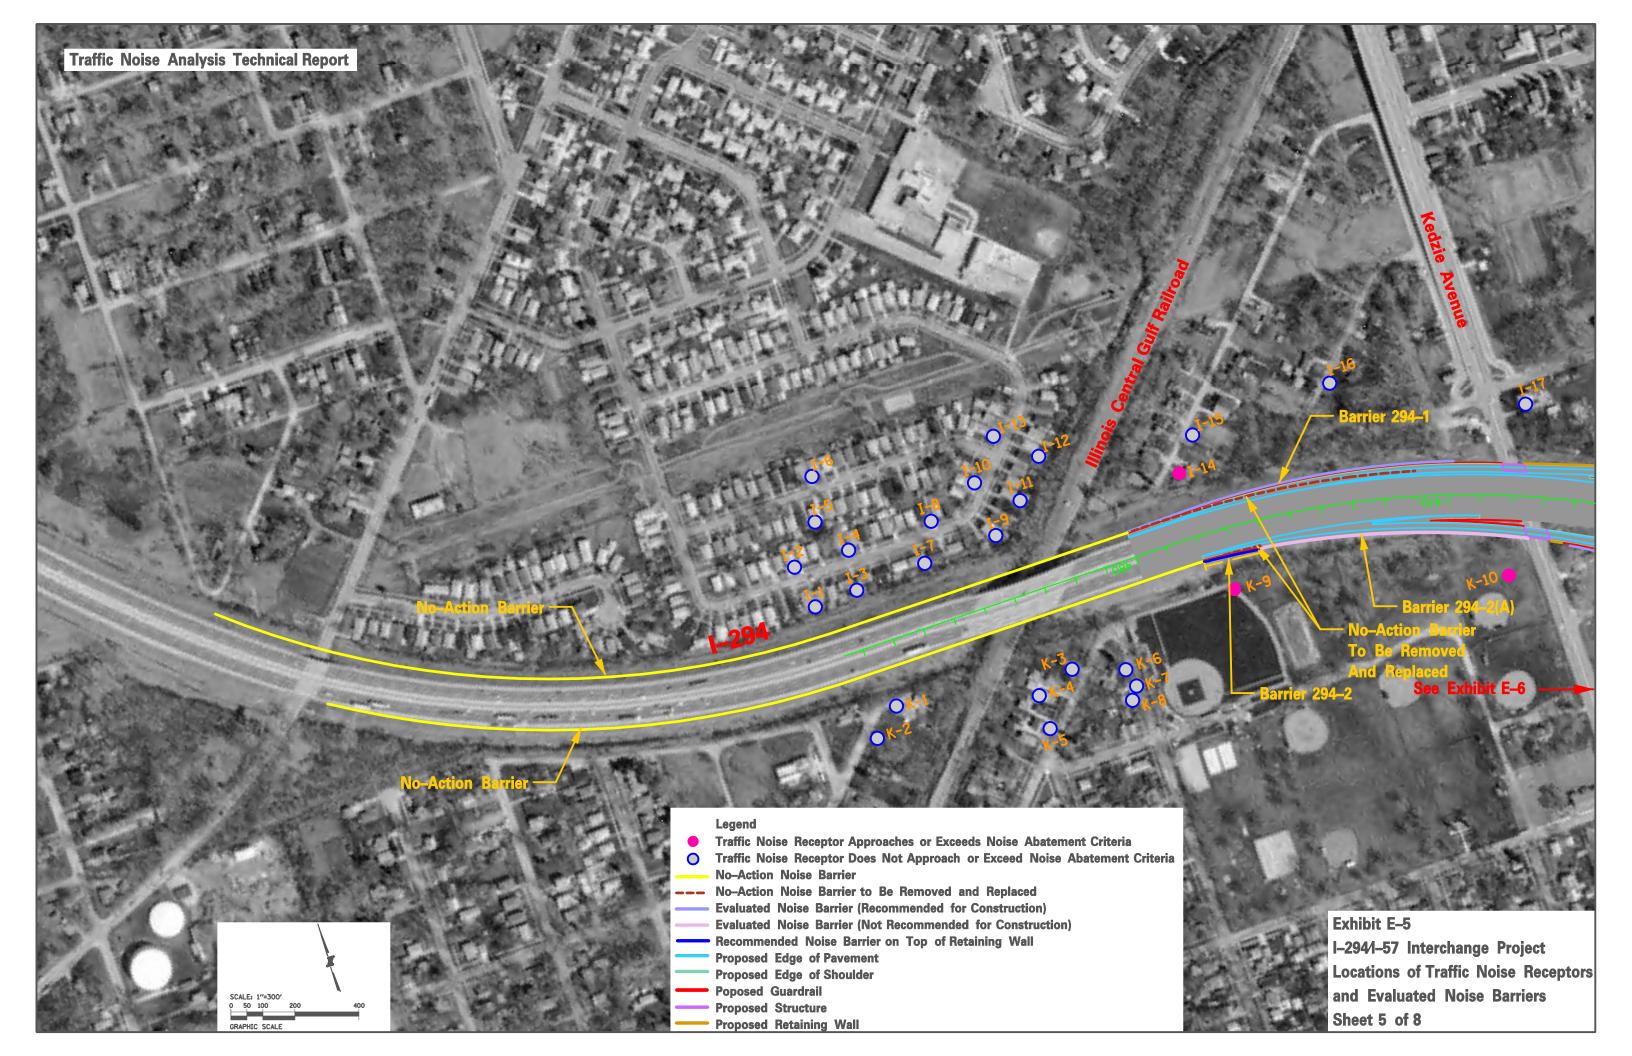

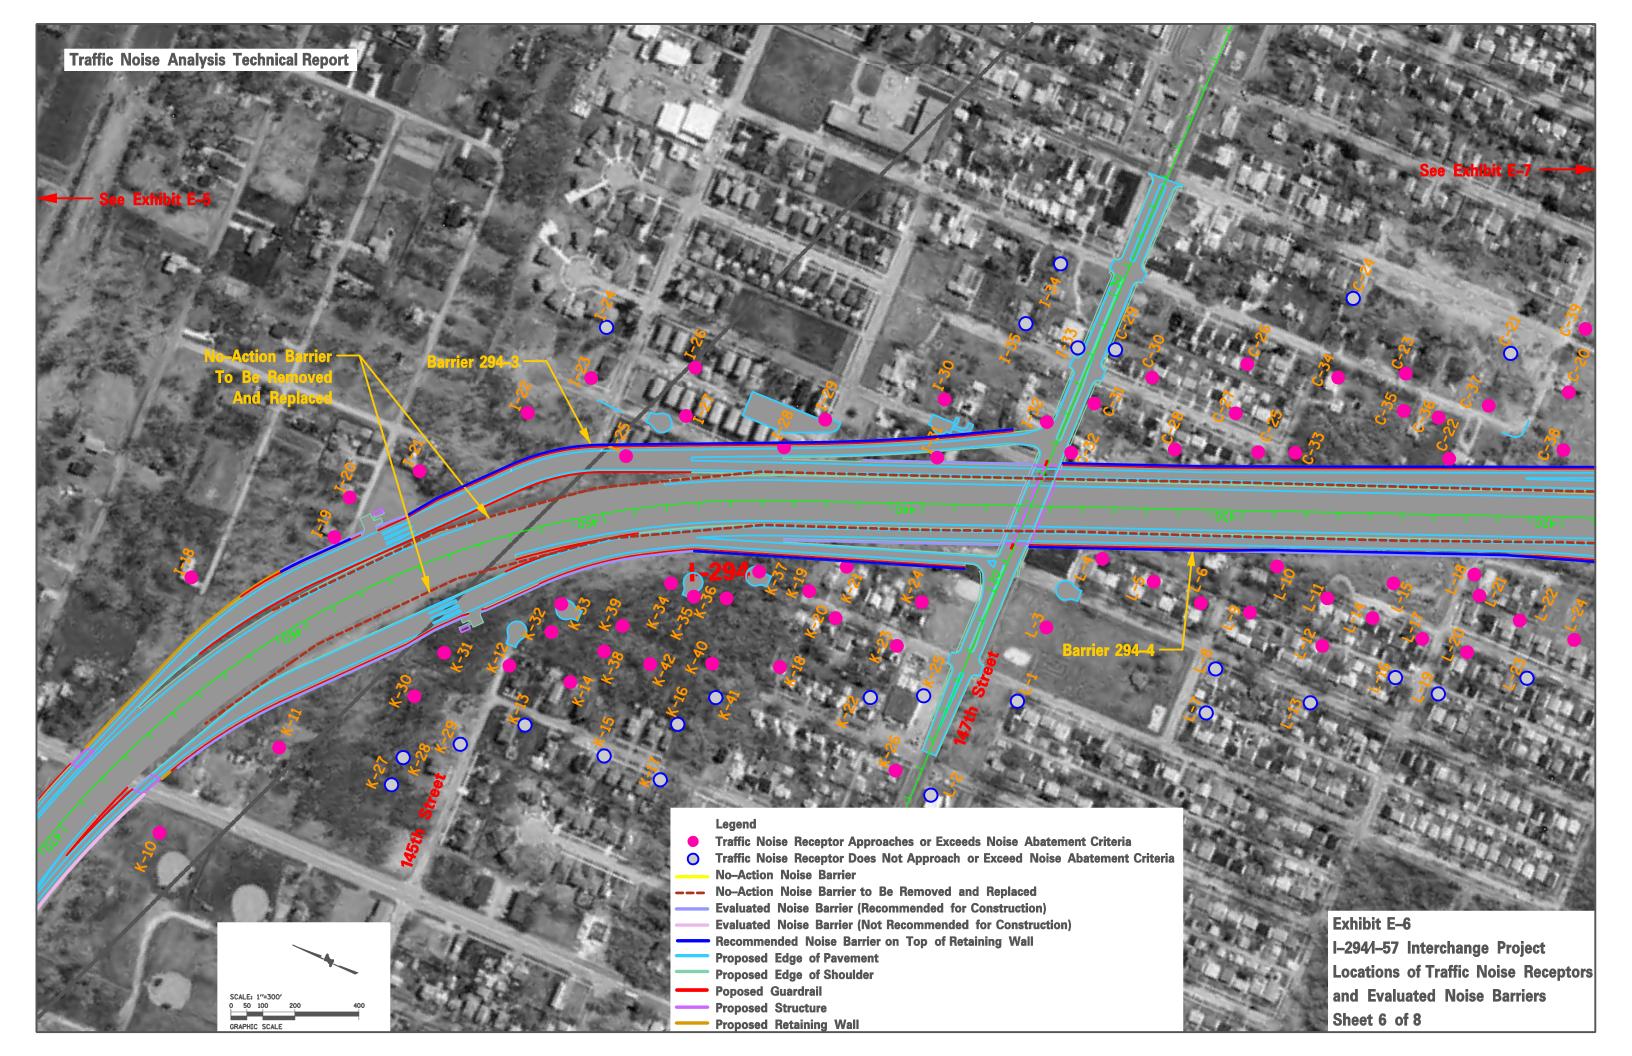


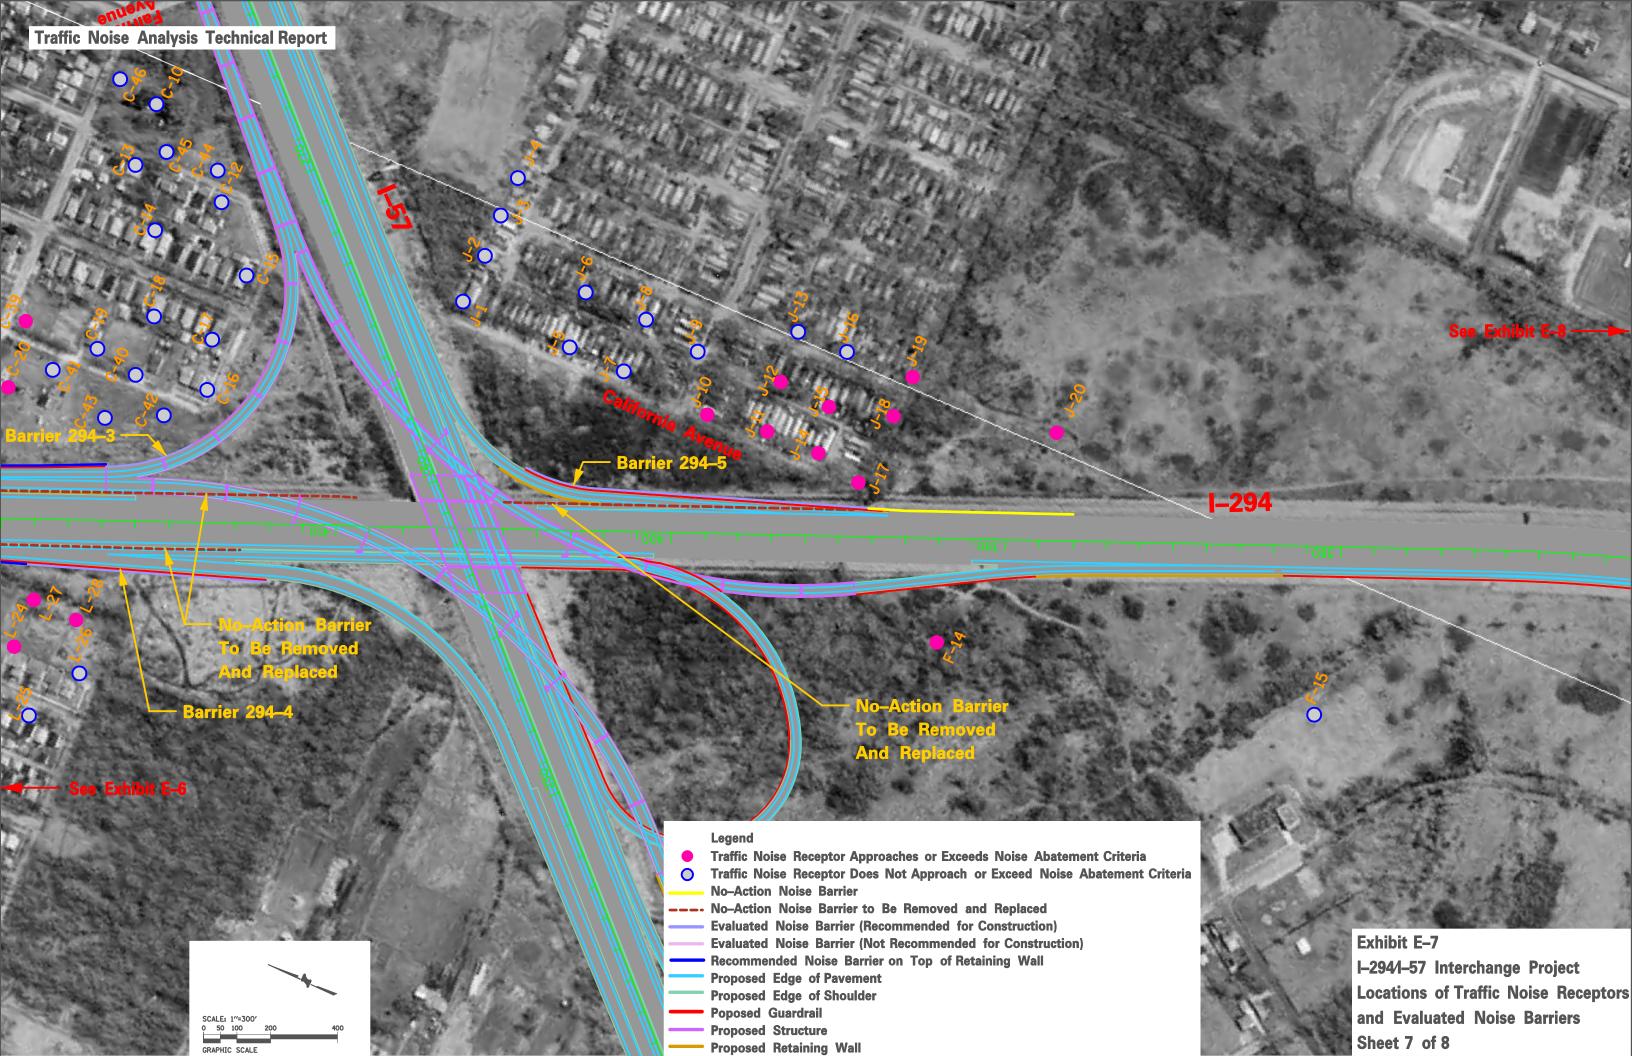

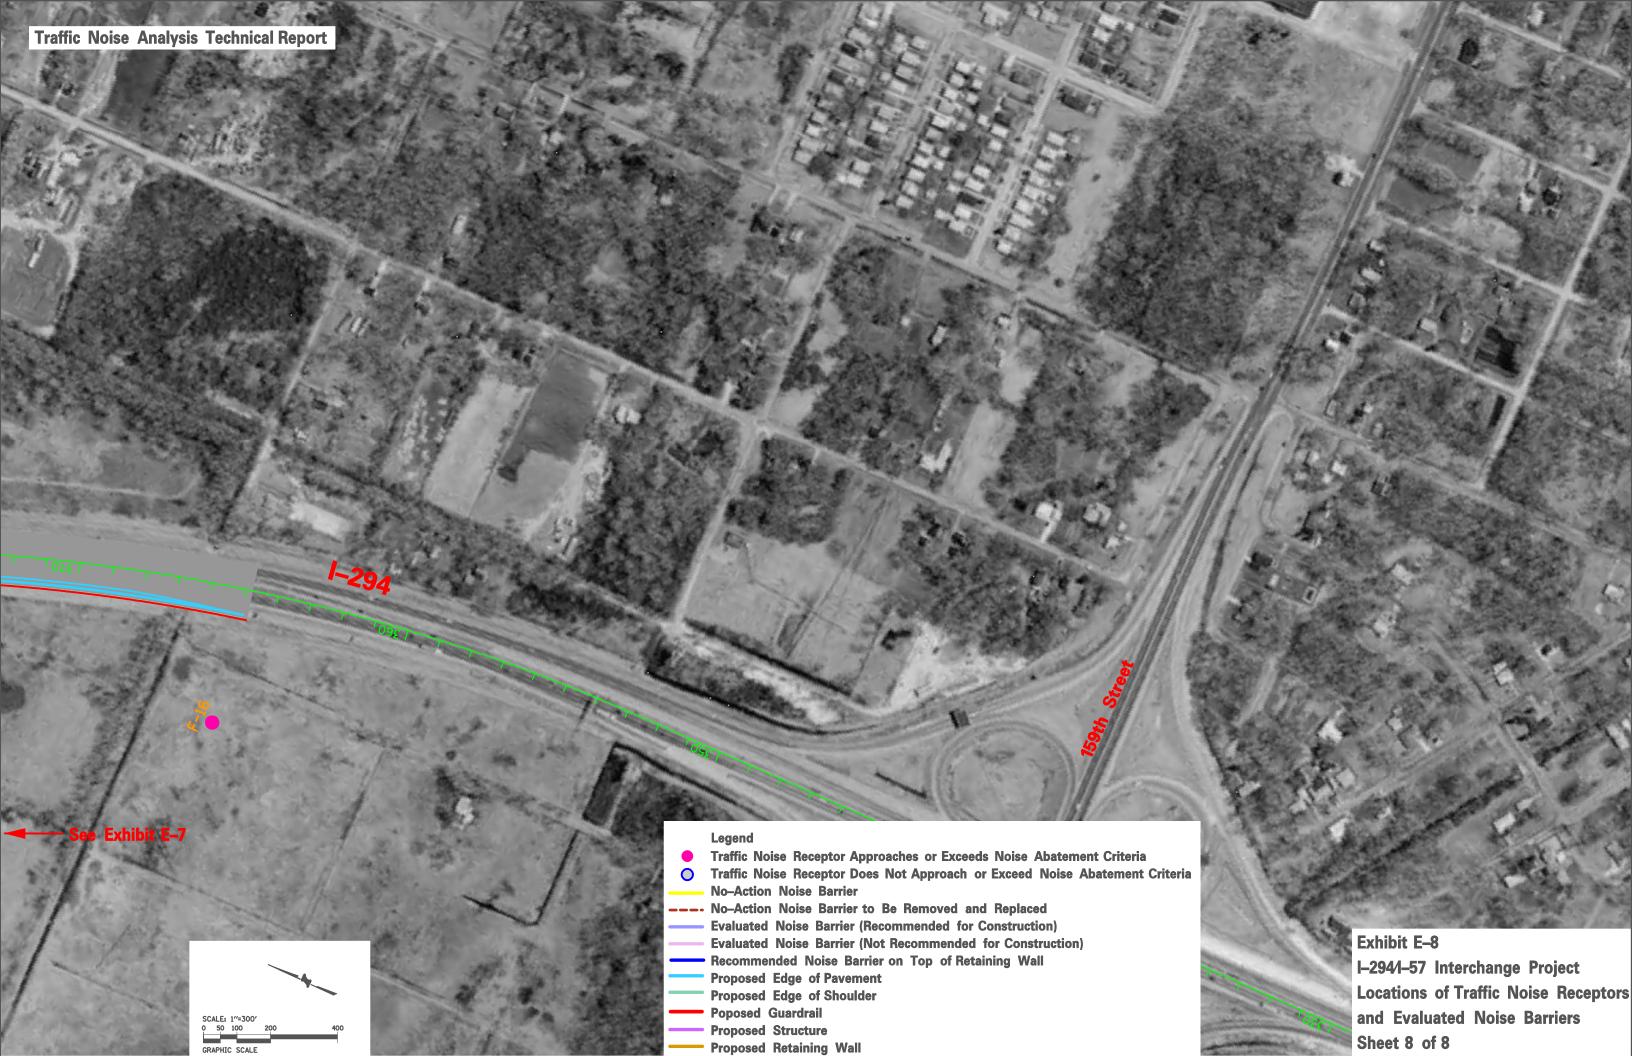

I-294/I-57 FA	Addandum -	Amandmani
1-/94/I-3/ FA	AOOEHOIIII -	Amenomeni

Appendix D Exhibits

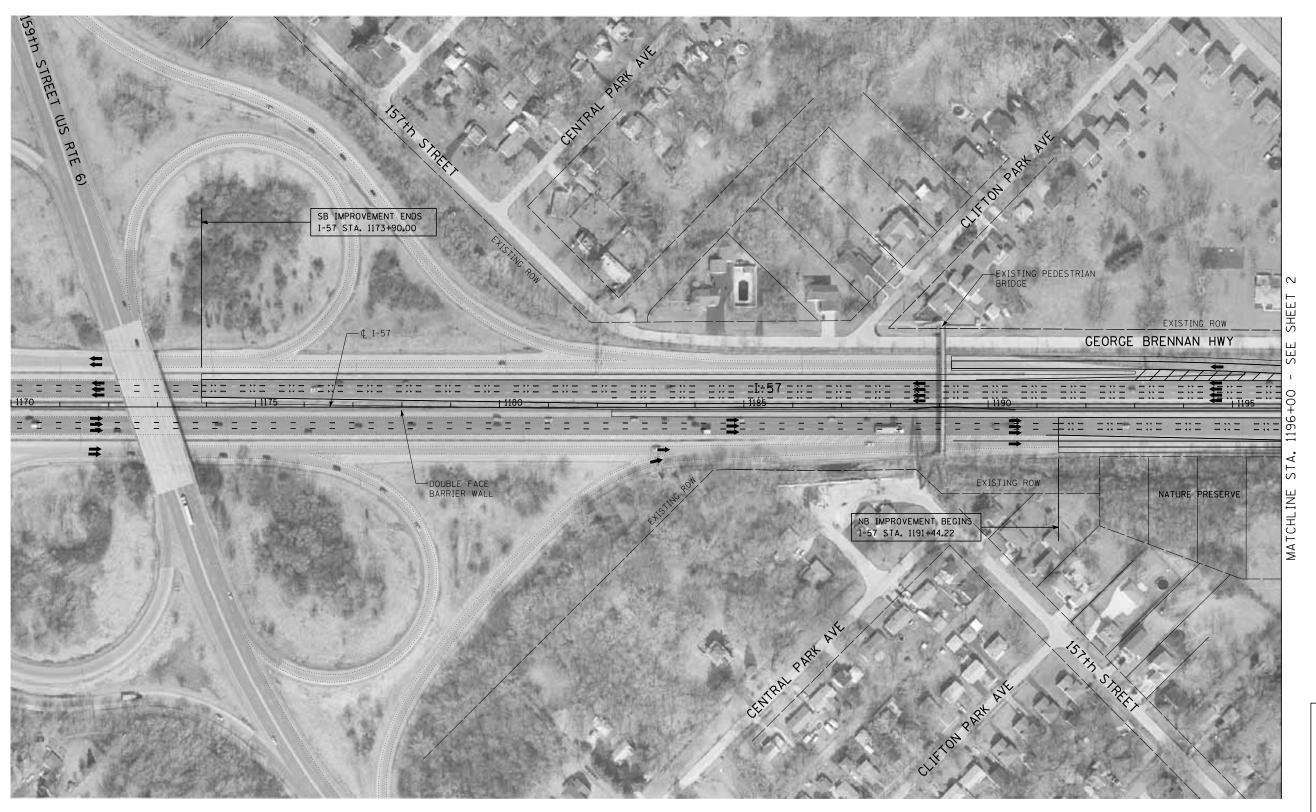

LEGEND:

XXX = PROPERTY NUMBER YYY = STREET NUMBER

PROPERTY ACQUISITION AREA

IMPACTED STRUCTURE

NOTES:

THE RIGHT OF WAY AND PROPERTY LINES SHOWN ON THE PLANS WERE OBTAINED FROM VARIOUS SOURCES AND ARE NOT BASED ON FIELD PROPERTY SURVEYS. THE FINAL STATIONS, OFFSETS AND AREAS OF POTENTIAL PROPERTY ACQUISITION CAN AND WILL VARY FROM THOSE SHOWN AND MUST BE FIELD VERIFIED BY PROPERTY SURVEY FROM A REGISTERED ILLINOIS LAND SURVEYOR.

)	10	00	200	
SCALE:	1′′	=	100'-0''	

	S	CALE: 1" = 1	00'-0''							LOCAT	TON N	IAP
	1–294 A1	T 1−57 INTE	RCHANG	E PROJEC	CT	D-5	F.A. RTE.	SEC.	TION	COUNTY	TOTAL SHEETS	SHEET NO.
POTENTIA	ALLY IMPAC	TED PROPEI	TIES/PR	OP. ROW	ACQUIS	RITION	57	(46-1	HBK-1	СООК	20	1
					7100011					CONTRACT	NO.	
: 1" = 100"	SHEET NO. 1	OF 20 SHEETS	STA.	1170+00	TO STA.	1196+00	FED. RO	AD DIST. NO.	ILLINOIS FED.	AID PROJECT		

FLIN INTERNATIONAL	USER NAME = \$USER\$	DESIGNED -	REVISED -
		DRAWN -	REVISED -
	PLOT SCALE = \$SCALE\$	CHECKED -	REVISED -
	PLOT DATE = 12/30/2009	DATE - 12/31/2008	REVISED -

STATE OF ILLINOIS DEPARTMENT OF TRANSPORTATION

SCALE: 1" = 10

p:\602540(57-294)\value enqineering\row exhibits\ea row exhibits\57294_ROW_plnsh02.dgn



STATE OF ILLINOIS
DEPARTMENT OF TRANSPORTATION

COUNTY TOTAL SHEET NO.

COOK 20 2

CONTRACT NO. D-5 F.A. 1−294 AT 1−57 INTERCHANGE PROJECT (46-1)HBK-1 POTENTIALLY IMPACTED PROPERTIES/PROP. ROW ACQUISITION SCALE: 1" = 100' SHEET NO. 2 OF 20 SHEETS STA. 1196+00 TO STA. 1221+00

LOCATION MAP

p:\602540(57-294)\value enqineering\row exhibits\ea row exhibits\57294_ROW_plnsh03.dqn

DESIGNED

CHECKED -

DATE

REVISED

REVISED


REVISED

REVISED


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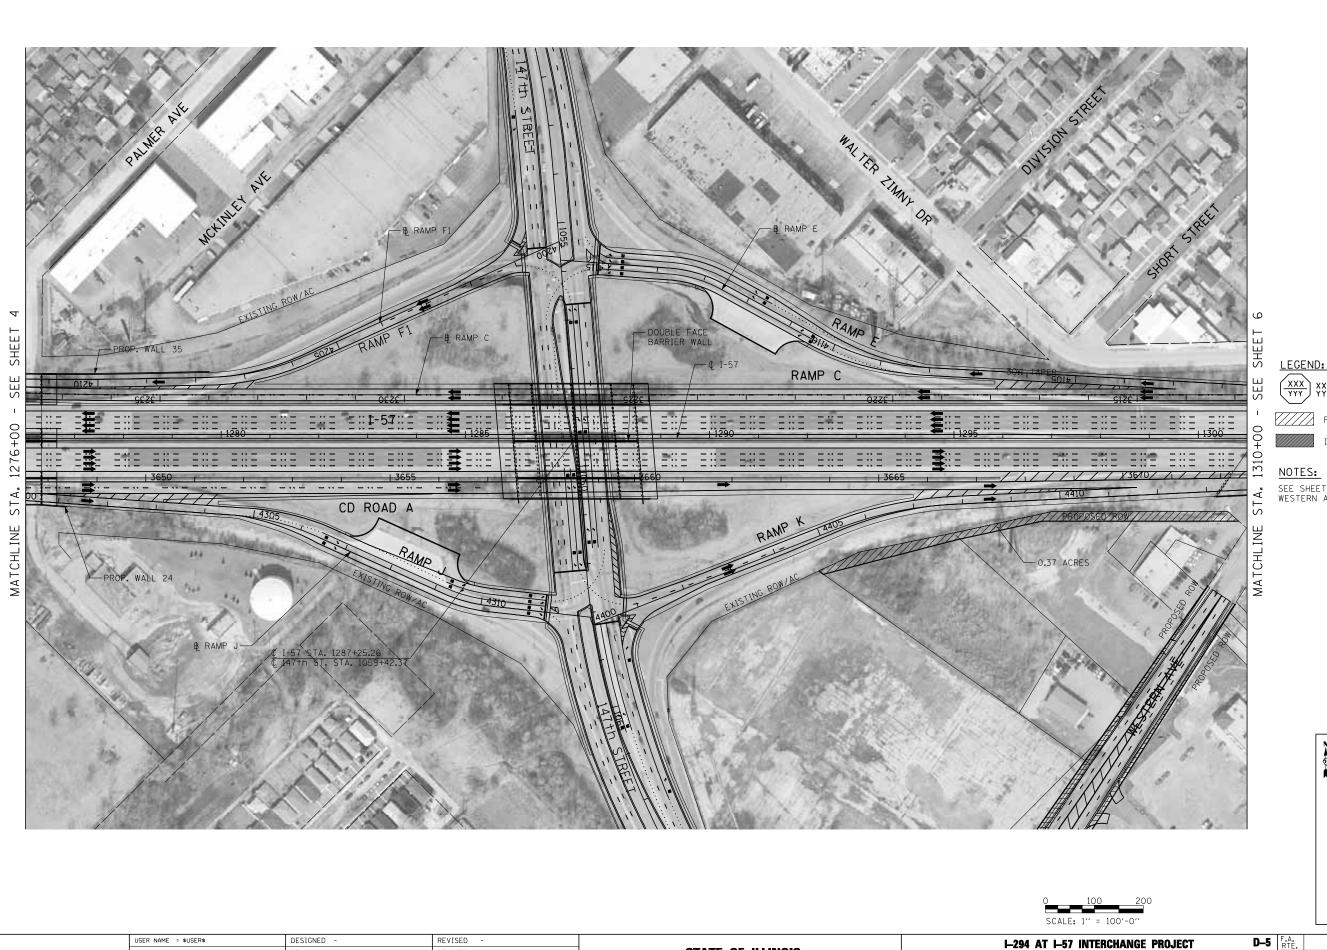
PLOT SCALE = \$SCALE\$

TYLIN INTERNATIONAL

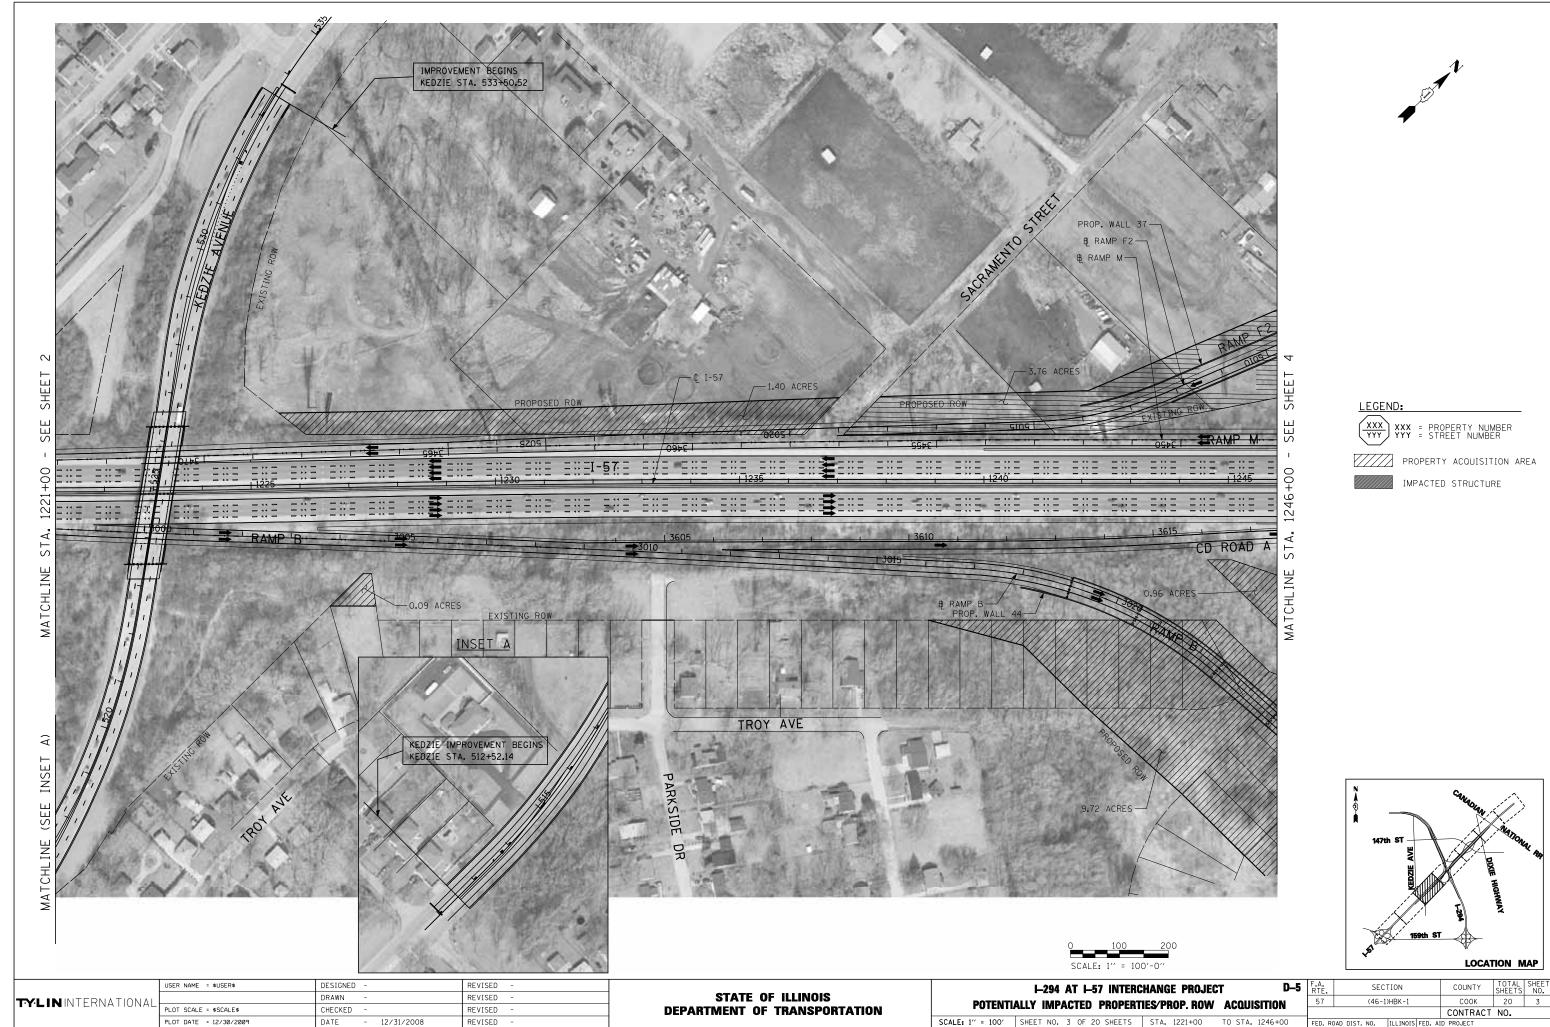


p:\602540(57-294)\value engineering\row exhibits\ea row exhibits\57294_ROW_plnsh04.dgn



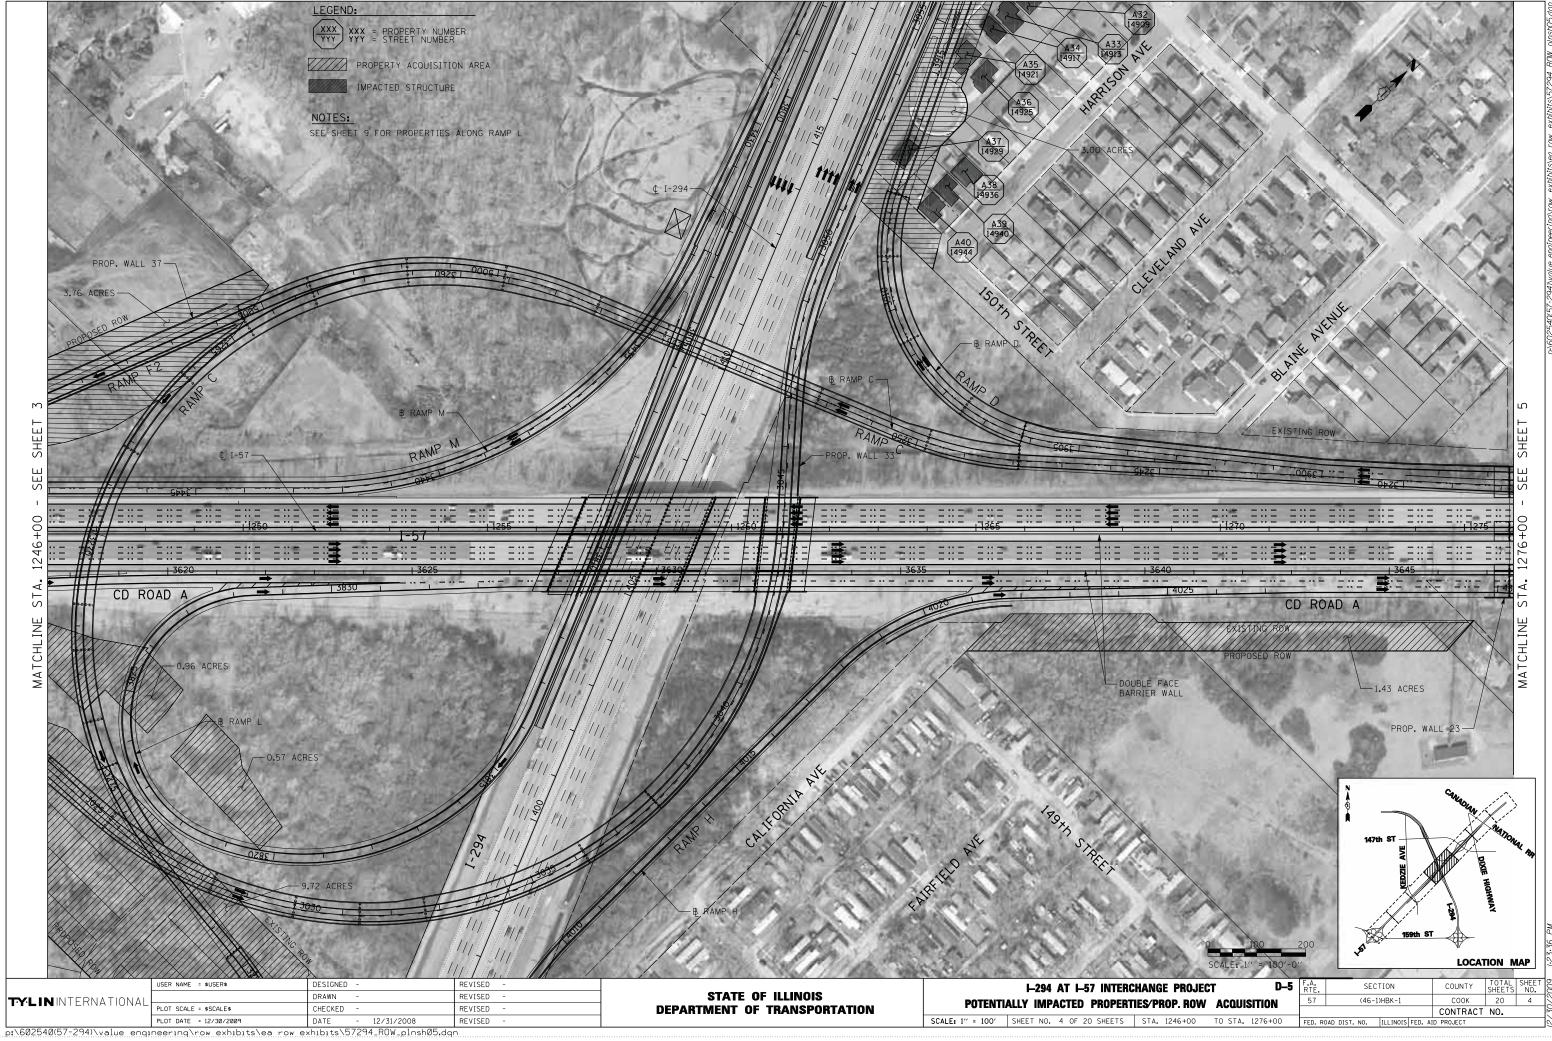

XXX = PROPERTY NUMBER
YYY = STREET NUMBER PROPERTY ACQUISITION AREA IMPACTED STRUCTURE SEE SHEET 20 FOR PROPERTIES ALONG WESTERN AVE.

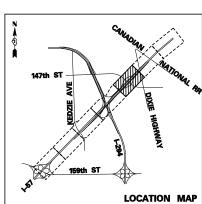

COUNTY TOTAL SHEET NO.

COOK 20 5

CONTRACT NO. D-5 F.A. SECTION (46-1)HBK-1

STATE OF ILLINOIS
DEPARTMENT OF TRANSPORTATION

POTENTIALLY IMPACTED PROPERTIES/PROP. ROW ACQUISITION SCALE: 1" = 100' SHEET NO. 5 OF 20 SHEETS STA. 1276+00 TO STA. 1301+00

CHECKED -


PLOT SCALE = \$SCALE\$

TYLIN INTERNATIONAL

REVISED

REVISED

REVISED

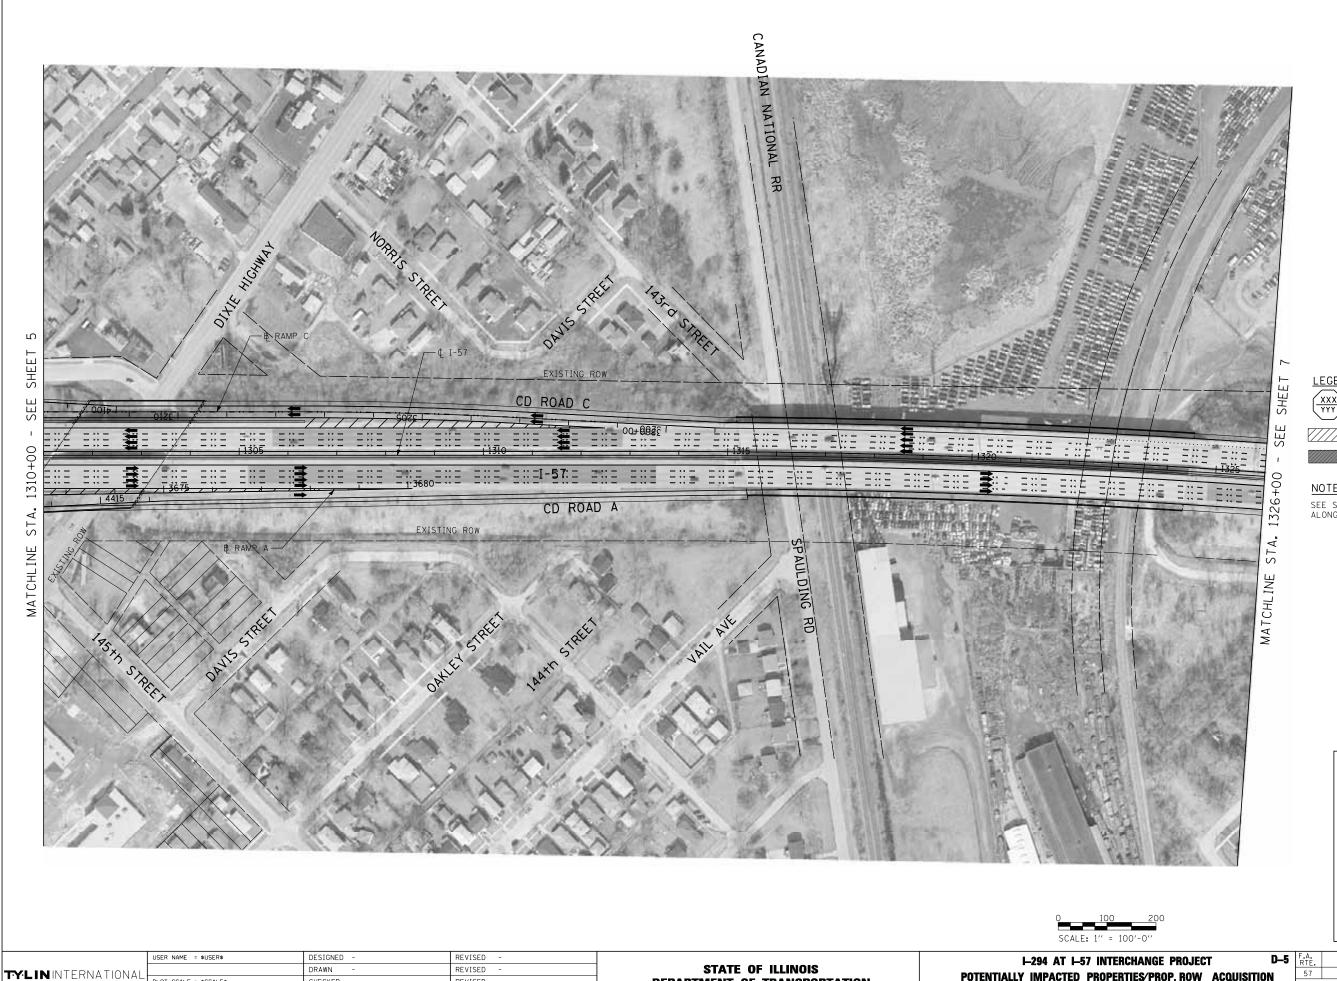



XXX XXX = PROPERTY NUMBER
YYY = STREET NUMBER




IMPACTED STRUCTURE



NOTES:

SEE SHEET 20 FOR PROPERTIES ALONG DIXIE HIGHWAY

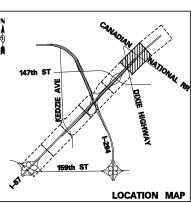

SECTION COUNTY TOTAL SHEET NO. COOK 20 6
CONTRACT NO. (46-1)HBK-1

STATE OF ILLINOIS
DEPARTMENT OF TRANSPORTATION


POTENTIALLY IMPACTED PROPERTIES/PROP. ROW ACQUISITION SCALE: 1" = 100' SHEET NO. 6 OF 20 SHEETS STA. 13010+00 TO STA. 1326+00

CHECKED

REVISED

REVISED

PLOT SCALE = \$SCALE\$

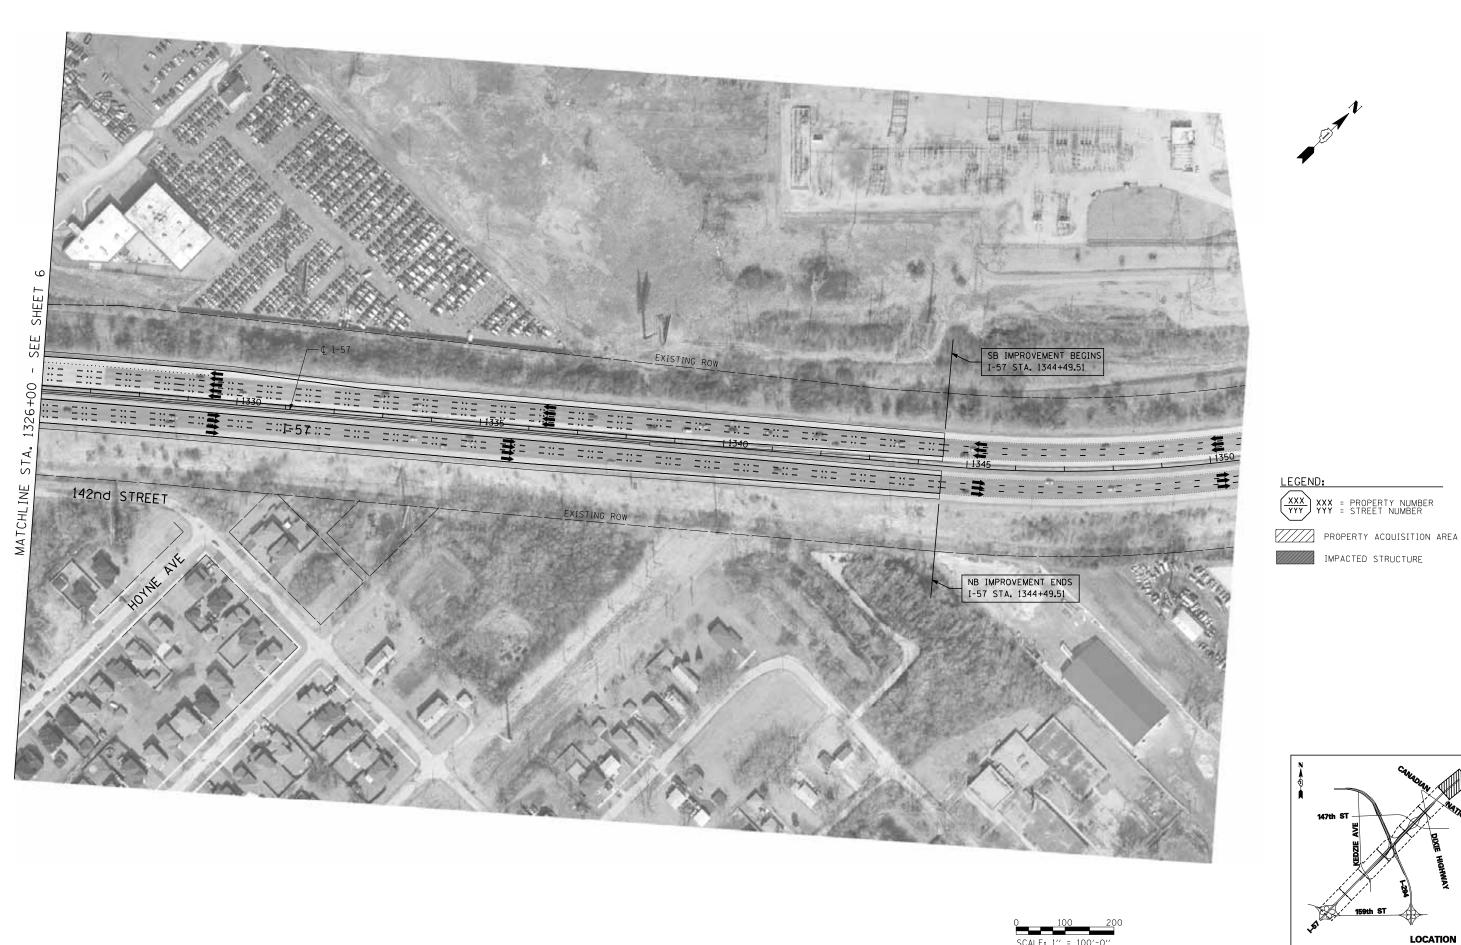

STATE OF ILLINOIS DEPARTMENT OF TRANSPORTATION

IMPACTED STRUCTURE

D-5 F.A. 1−294 AT 1−57 INTERCHANGE PROJECT POTENTIALLY IMPACTED PROPERTIES/PROP. ROW ACQUISITION

LOCATION MAP COUNTY TOTAL SHEET NO.

COOK 20 7

CONTRACT NO. SECTION (46-1)HBK-1

PLOT DATE = 12/30/2009 DATE REVISED p:\602540(57-294)\value engineering\row exhibits\ea row exhibits\57294_ROW_plnsh08.dqn

DESIGNED

CHECKED -

REVISED

REVISED


REVISED

USER NAME = \$USER\$


PLOT SCALE = \$SCALE\$

TYLIN INTERNATIONAL


SCALE: 1" = 100' SHEET NO. 7 OF 20 SHEETS STA. 1326+00 TO STA. 1350+00

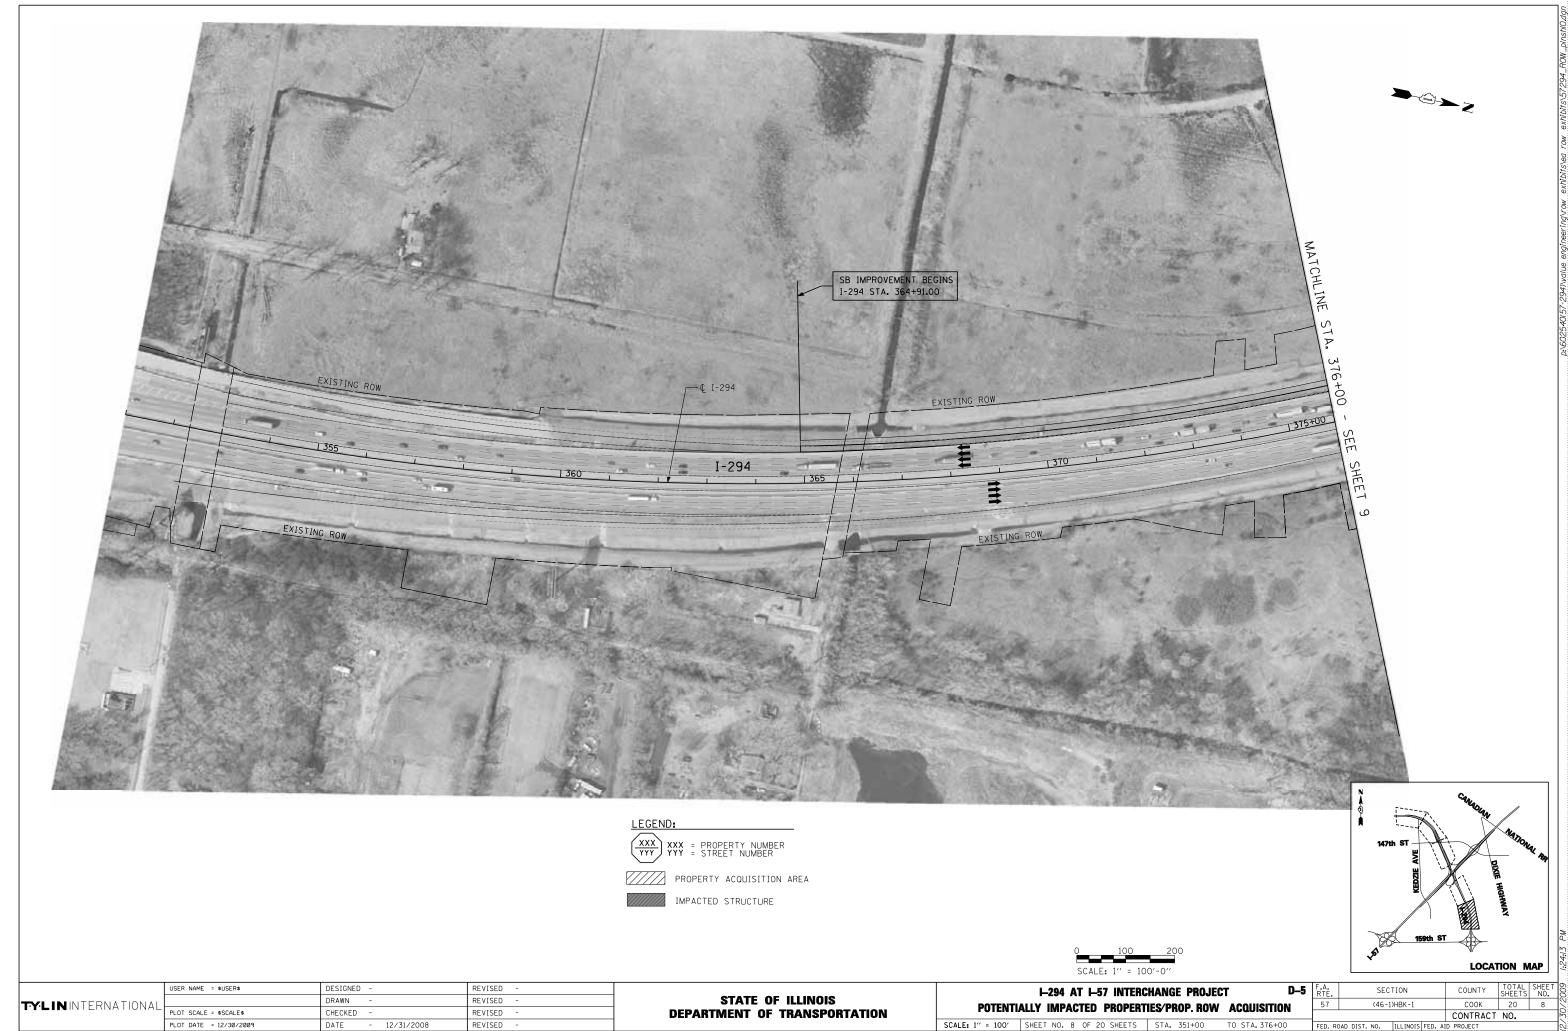

PLOT DATE = 12/30/2009 DATE - 12/31/2008 Fp:\602540(57-294)\value enqineering\row exhibits\ea row exhibits\57294_ROW_plnsh10.dgn

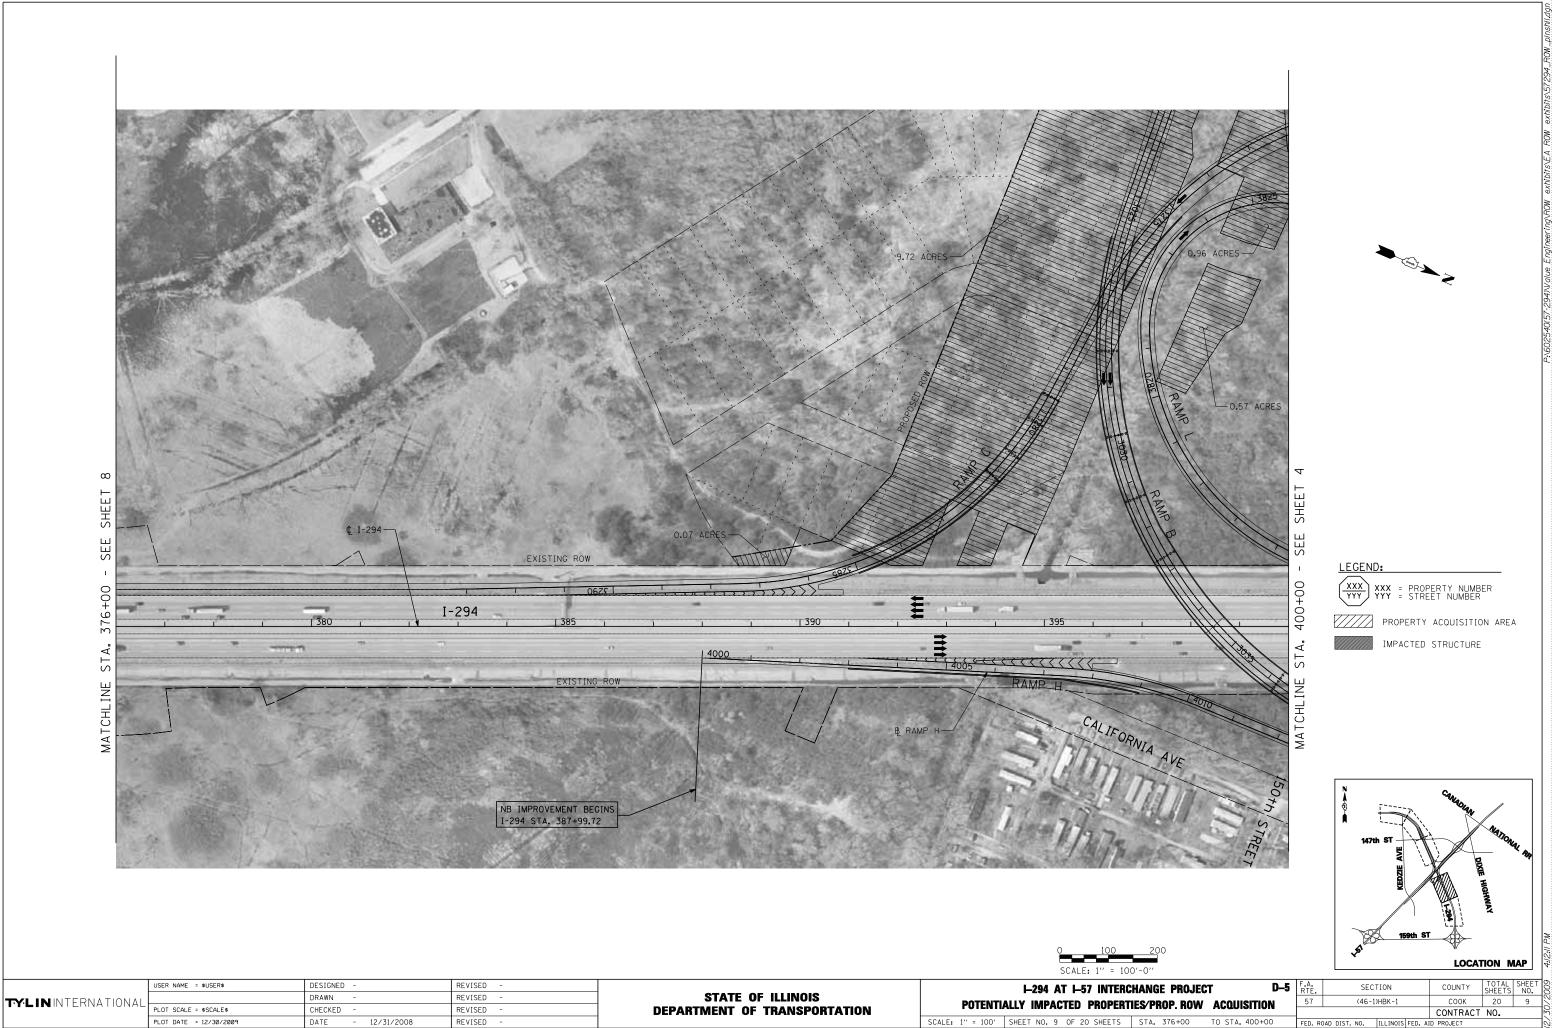

PLOT DATE = 12/30/2009 DATE - 12/31/2008 RIP:\602540(57-294)\Value Engineering\ROW exhibits\EA ROW exhibits\57294_ROW_plnsh11.dqn

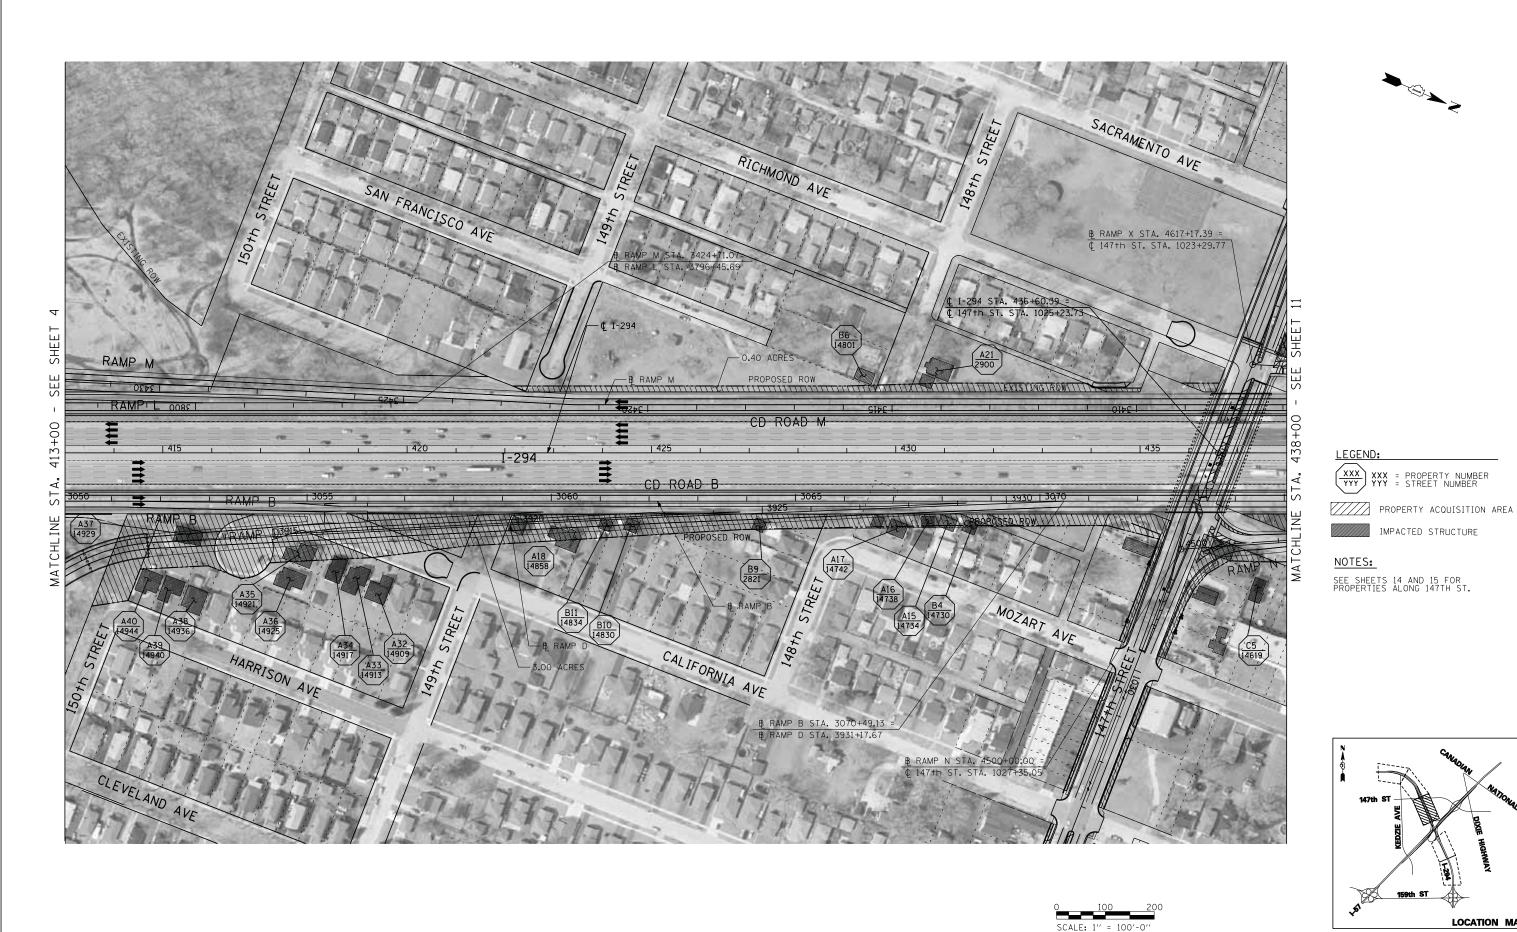

STATE OF ILLINOIS

DEPARTMENT OF TRANSPORTATION

D-5 F.A. SECTION COUNTY TOTAL SHEET NO. **1**–294 AT 1–57 INTERCHANGE PROJECT COOK 20 10 (46-1)HBK-1 POTENTIALLY IMPACTED PROPERTIES/PROP. ROW ACQUISITION SCALE: 1" = 100' SHEET NO. 10 OF 20 SHEETS STA. 413+00 FED. ROAD DIST. NO. | ILLINOIS FED. AID PROJECT

LOCATION MAP

PLOT DATE = 12/30/2009 DATE - 12/31/2008 REVISED p:\602540(57-294)\value enqineering\row exhibits\ea row exhibits\57294_ROW_plnsh12.dgn

DESIGNED

CHECKED

REVISED

REVISED

REVISED

USER NAME = \$USER\$


PLOT SCALE = \$SCALE\$

TY:LIN INTERNATIONAL



PLOT DATE = 12/30/2009 DATE - 12/31/2008
p:\602540(57-294)\value engineering\row exhibits\ea row exhibits\57294_ROW_plnsh13.dgn

SCALE: 1" = 100' SHEET NO. 11 OF 20 SHEETS STA. 438+00 TO STA. 463+00

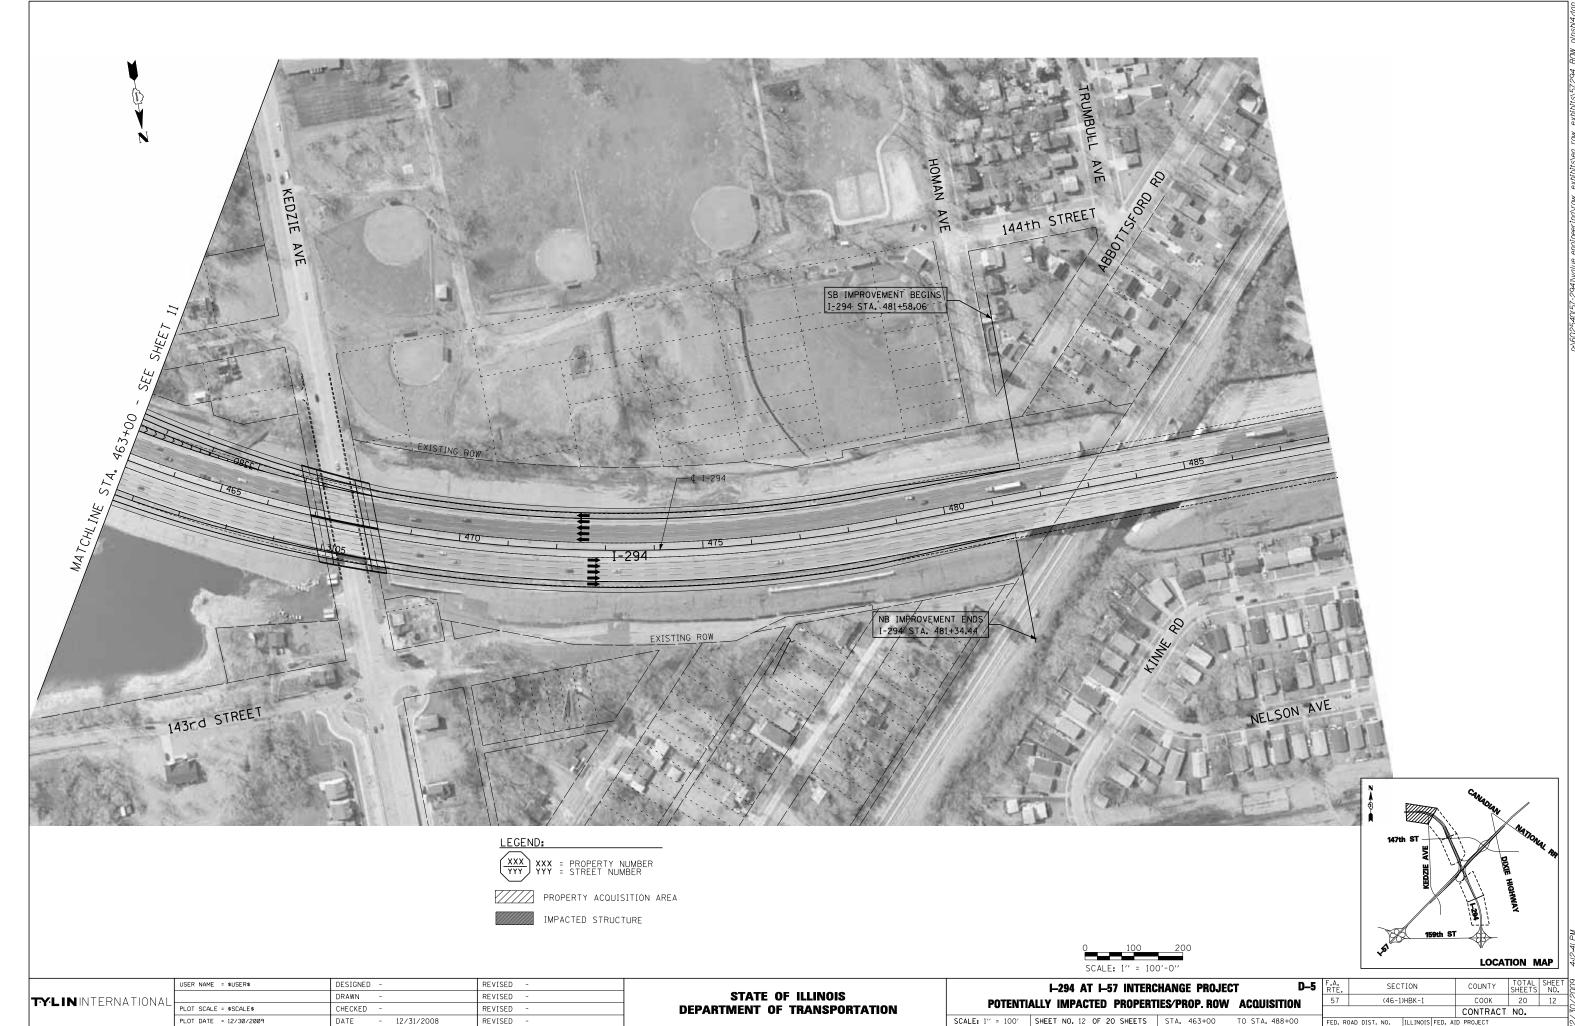

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SCALE: 1" = 100' SHEET NO. 12 OF 20 SHEETS STA. 463+00 TO STA. 488+00



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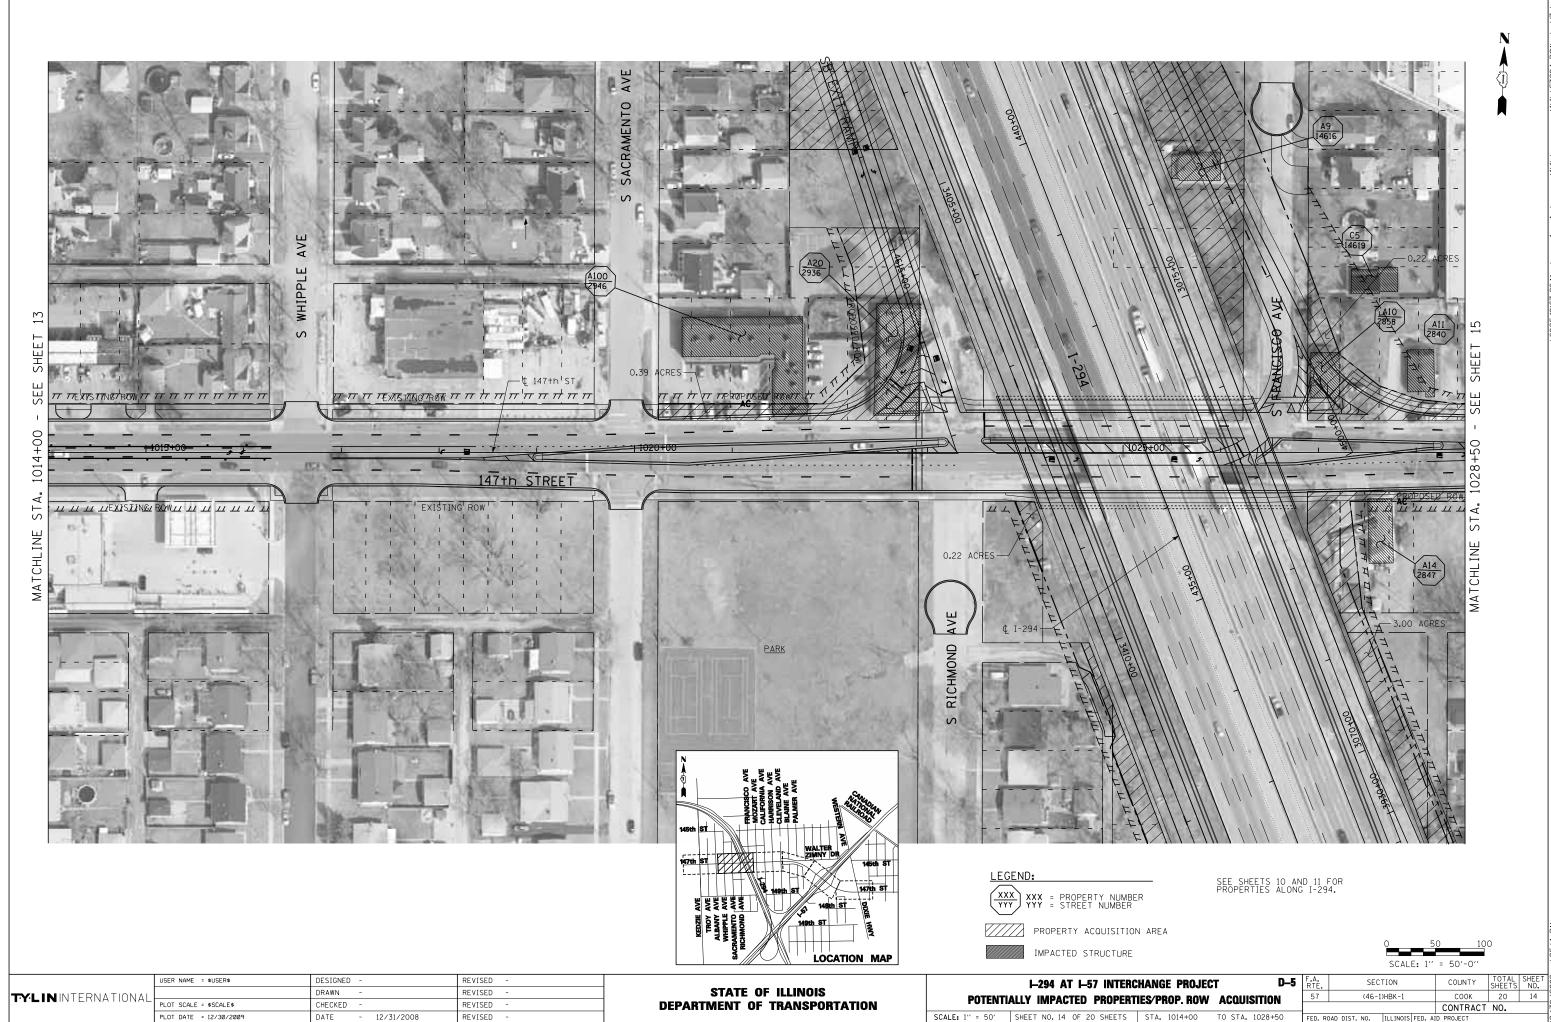
STATE OF ILLINOIS
DEPARTMENT OF TRANSPORTATION

POTENTIALLY IMPACTED PROPERTIES/PROP. ROW ACQUISITION SCALE: 1" = 50' SHEET NO. 13 OF 20 SHEETS STA. 1000+00 TO STA. 1014+00


COOK 20 13 (46-1)HBK-1 FED. ROAD DIST. NO. | ILLINOIS FED. AID PROJECT

DATE REVISED

REVISED



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147th ST AVE AVE LOCATION MAP

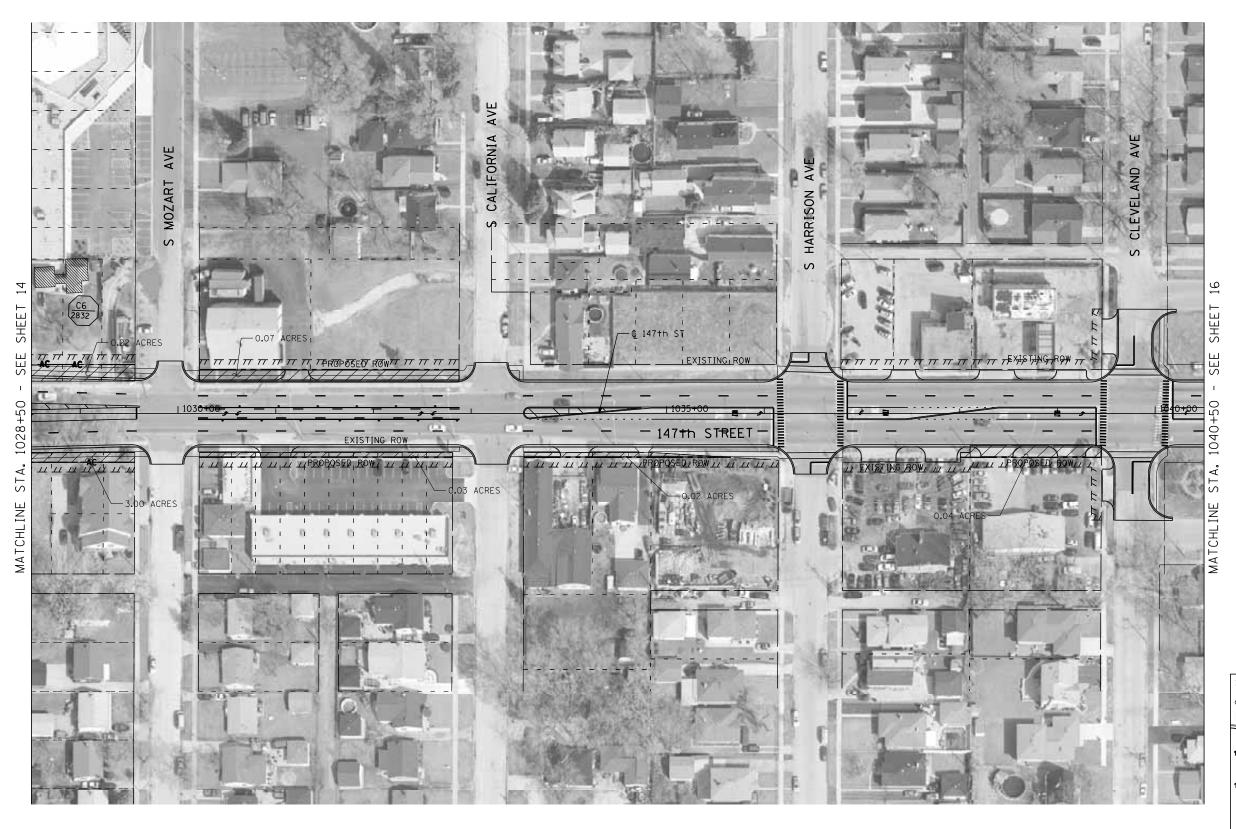LEGEND:

XXX = PROPERTY NUMBER
YYY = STREET NUMBER

PROPERTY ACQUISITION AREA IMPACTED STRUCTURE

1–294 AT 1–57 INTERCHANGE PROJECT POTENTIALLY IMPACTED PROPERTIES/PROP. ROW ACQUISITION SCALE: 1" = 50' SHEET NO. 15 OF 20 SHEETS STA. 1028+50 TO STA. 1040+50

D-5 F.A. RTE. SECTION COUNTY TOTAL SHEET NO. COOK 20 15 (46-1)HBK-1 FED. ROAD DIST. NO. ILLINOIS FED. AID PROJECT

PLOT DATE = 12/30/2009 DATE p:\602540(57-294)\value enqineering\row exhibits\ea row exhibits\57294_ROW_plnsh18.dgn

USER NAME = \$USER\$

TYLININTERNATIONAL PLOT SCALE = *SCALE*

STATE OF ILLINOIS DEPARTMENT OF TRANSPORTATION


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REVISED

DESIGNED

CHECKED -



PLOT DATE = 12/30/2009 DATE - 12/31/2008 p:\602540(57-294)\value engineering\row exhibits\ea row exhibits\57294_ROW_plnsh19.dgn

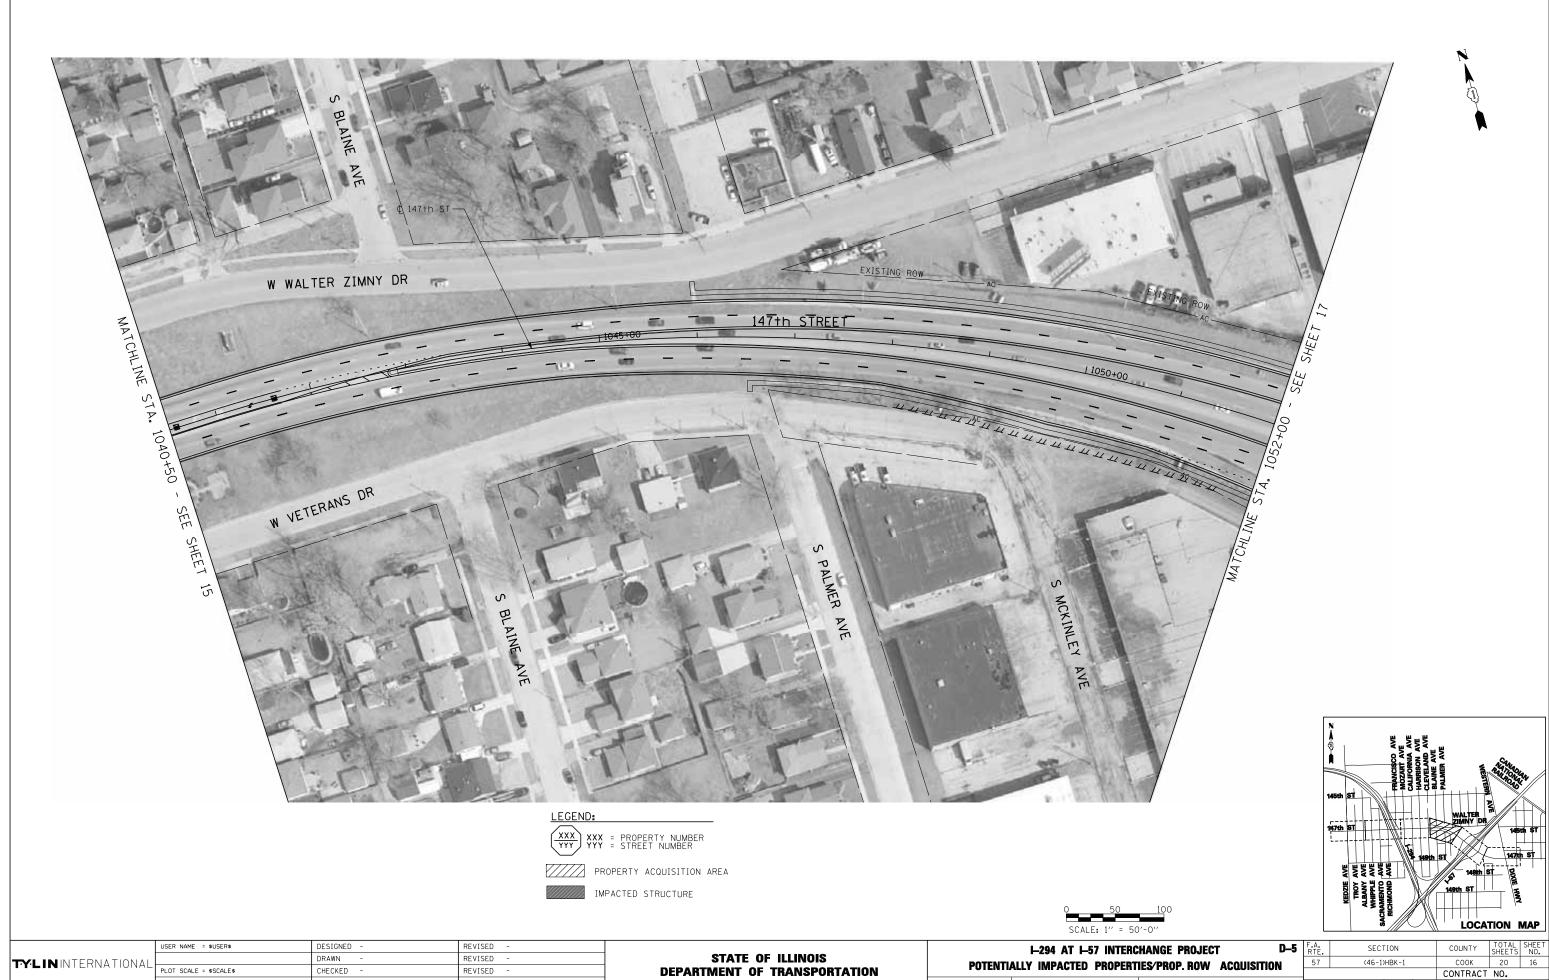
REVISED

POTENTIALLY IMPACTED PROPERTIES/PROP. ROW ACQUISITION SCALE: 1" = 50' SHEET NO. 16 OF 20 SHEETS STA. 1040+50 TO STA. 1052+00


COUNTY TOTAL SHEET NO.

COOK 20 16


CONTRACT NO.

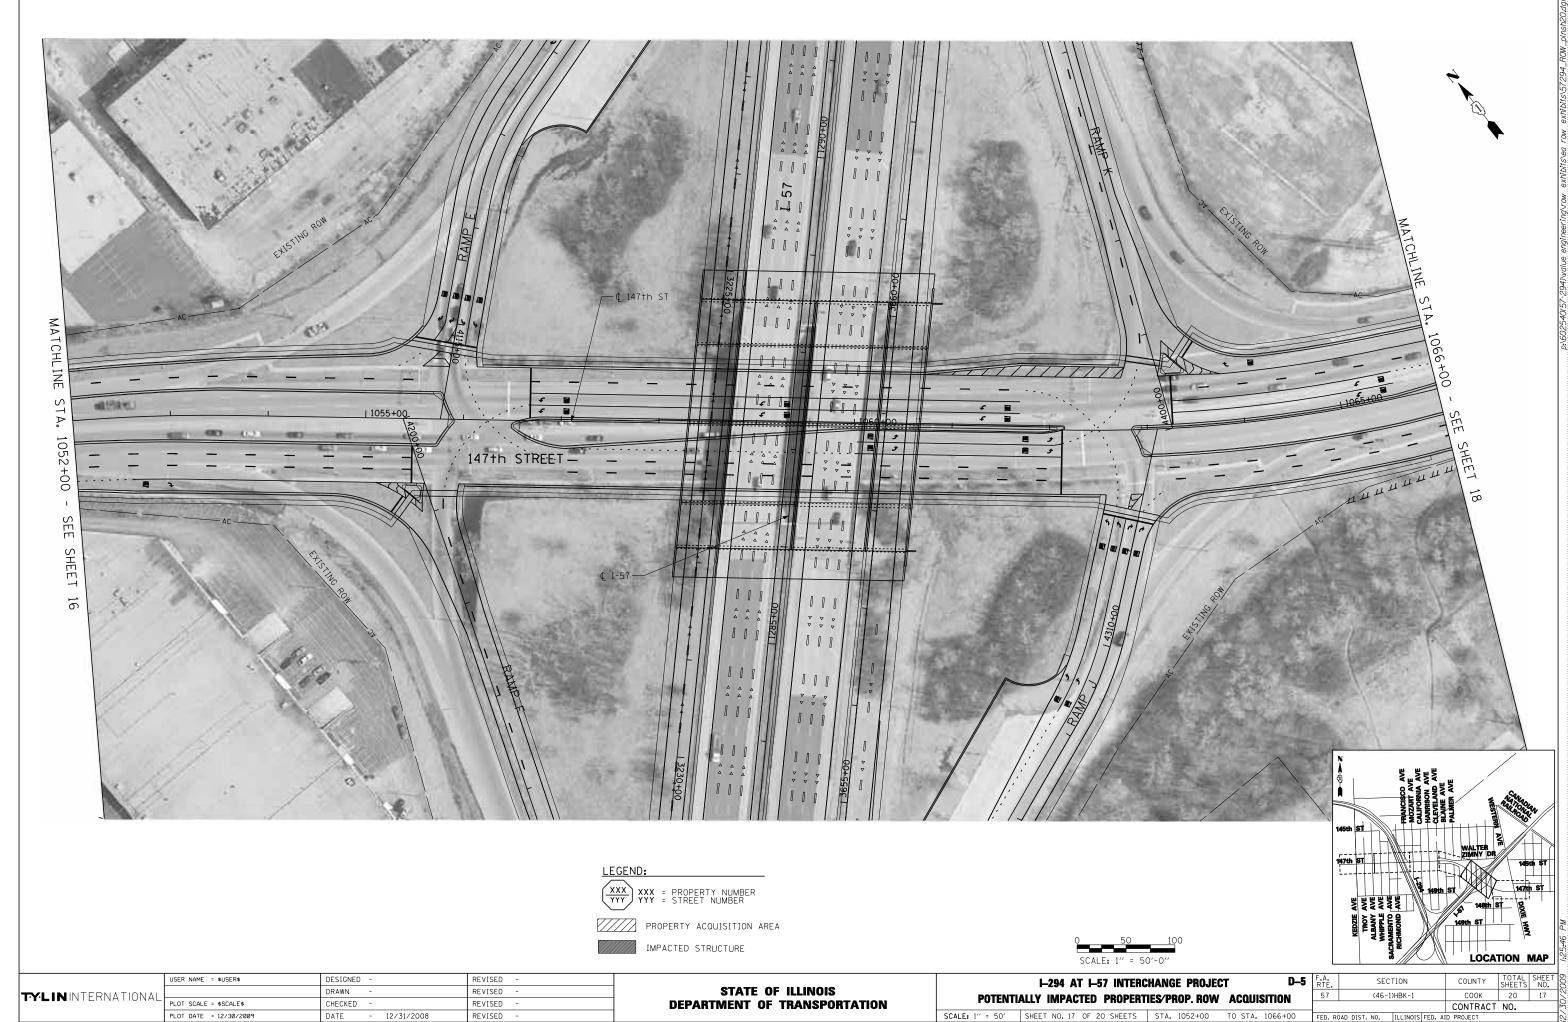

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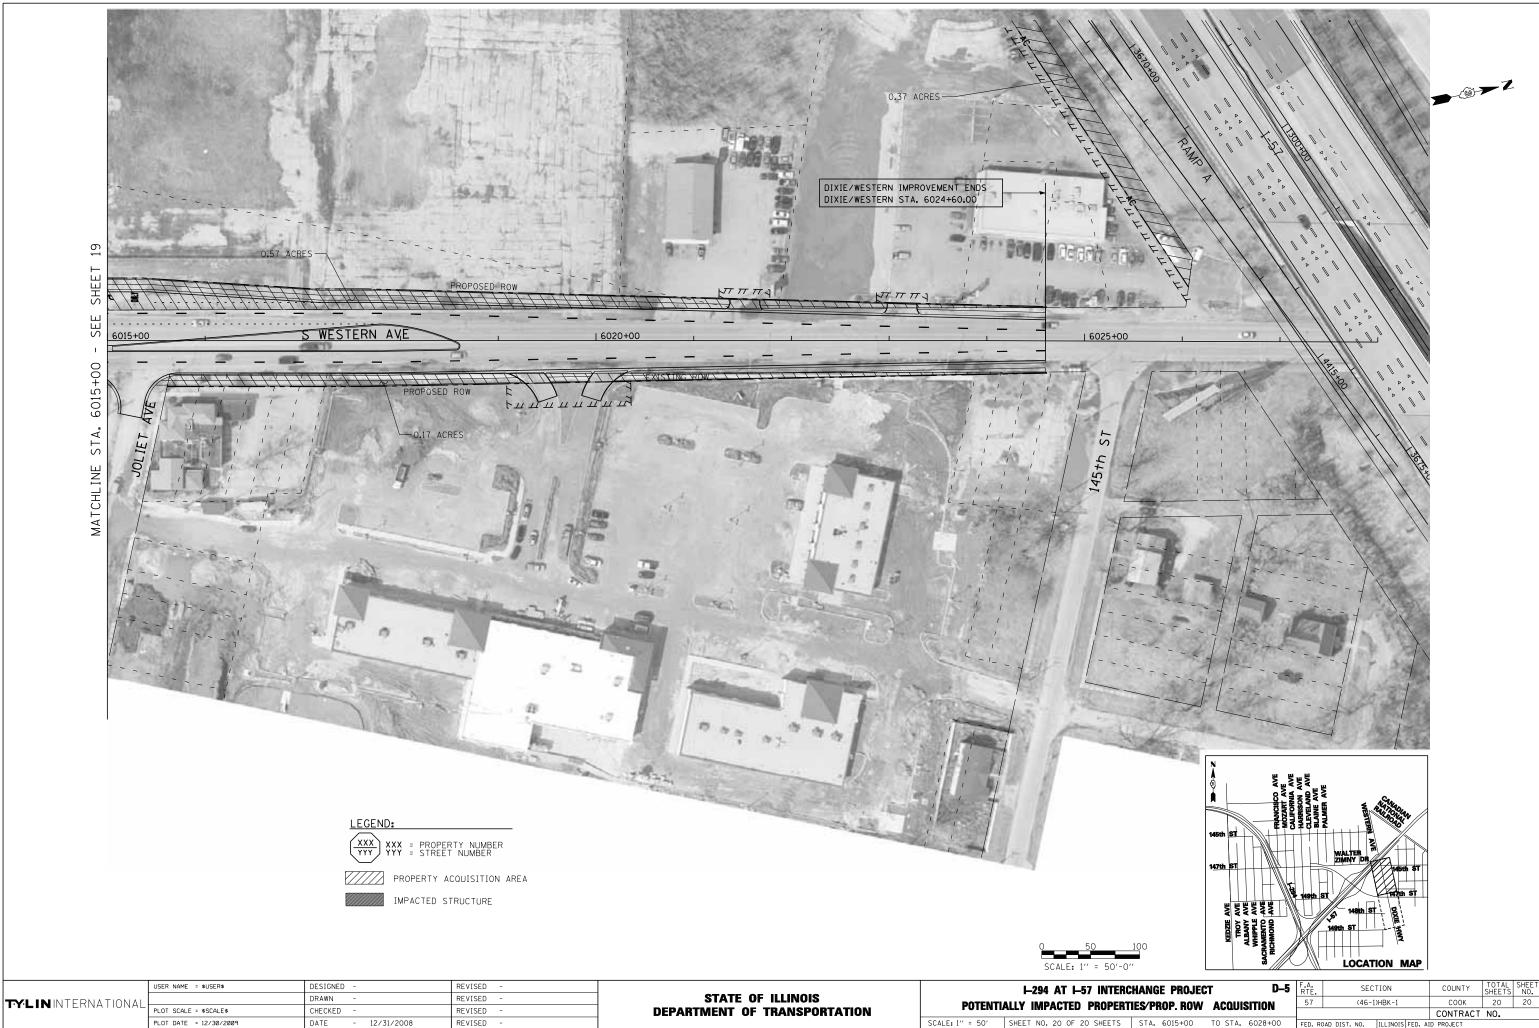
LOCATION MAP COUNTY TOTAL SHEET NO.

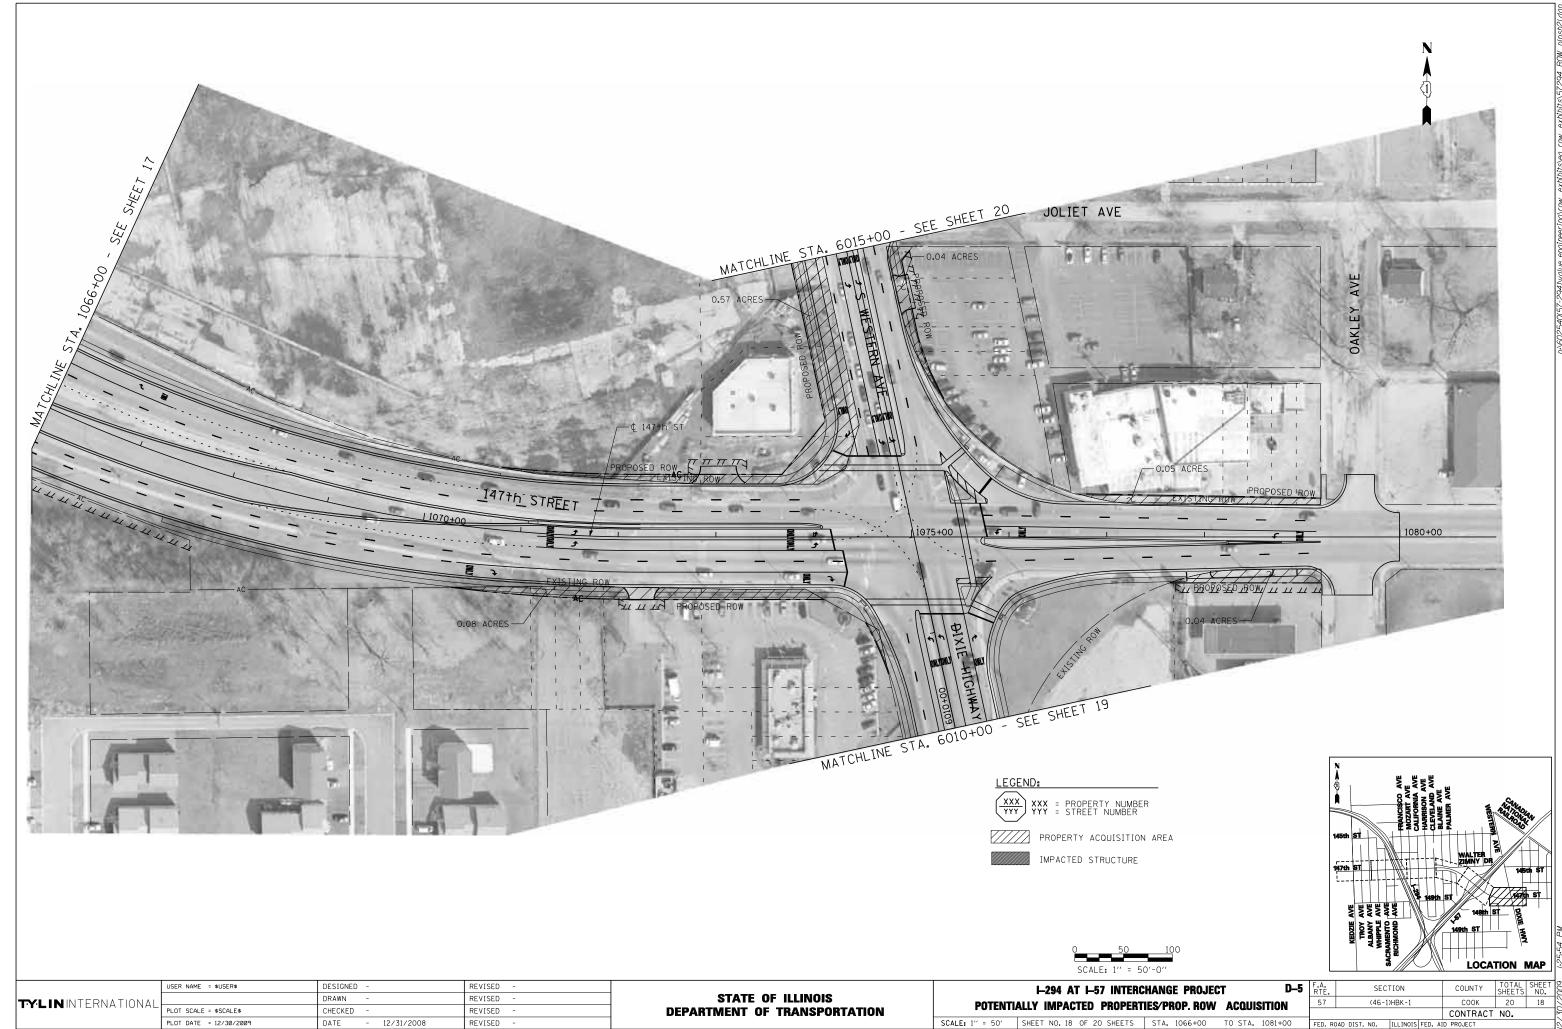COOK 20 19

CONTRACT NO. (46-1)HBK-1

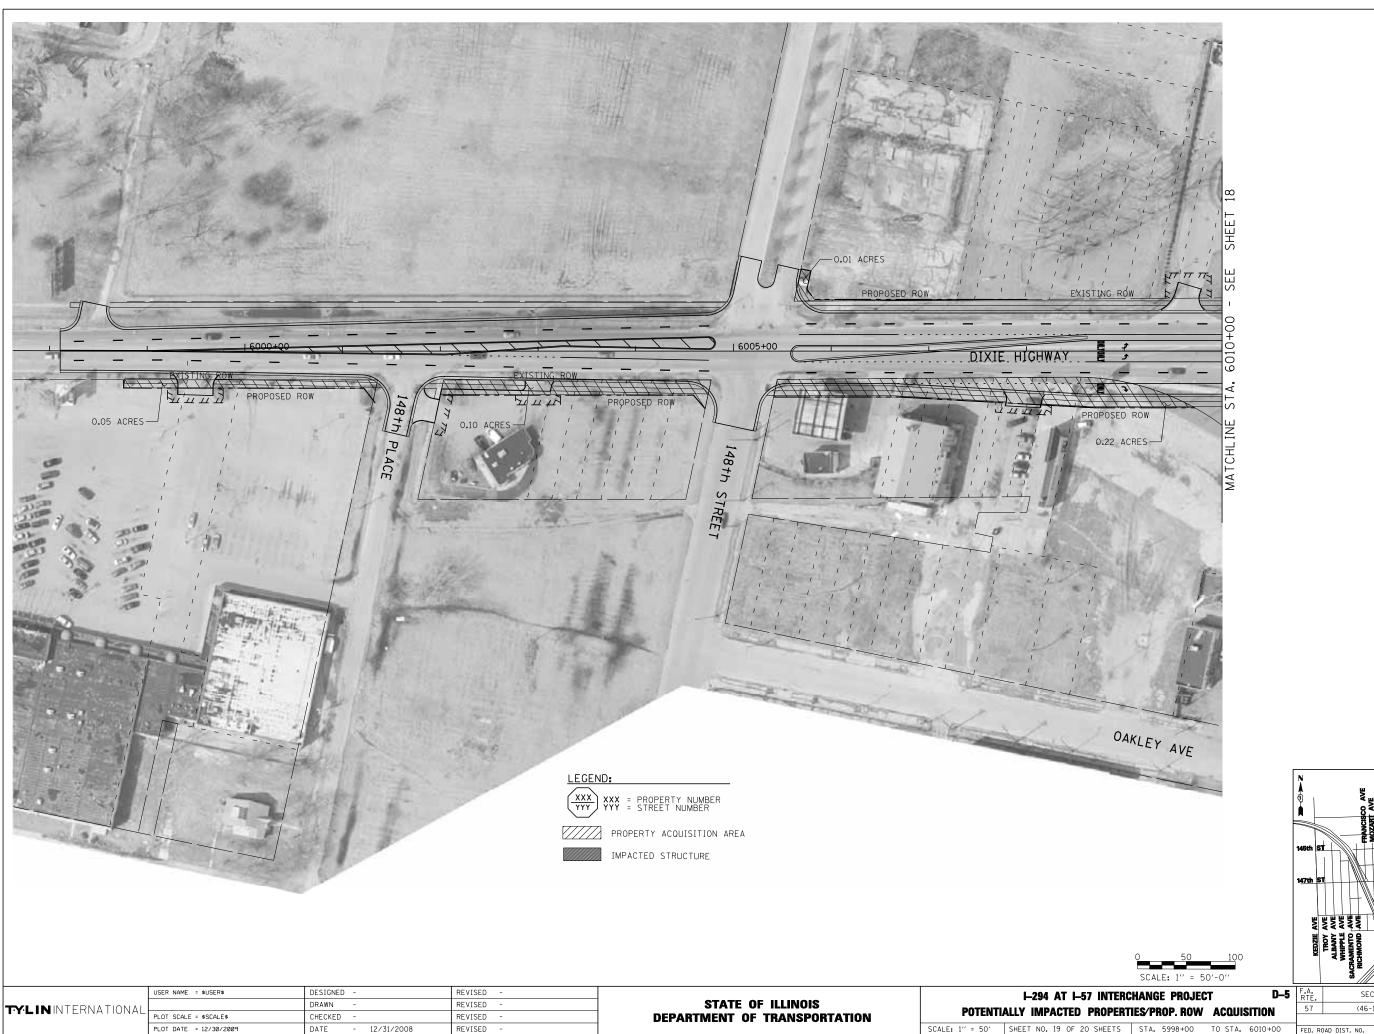SCALE: 1" = 50' SHEET NO. 19 OF 20 SHEETS STA. 5998+00 TO STA. 6010+00

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p:\602540(57-294)\value engineering\row exhibits\ea row exhibits\57294_ROW_plnsh23.dgn

SCALE: 1" = 50' SHEET NO. 20 OF 20 SHEETS STA. 6015+00 TO STA. 6028+00